

ADDENDUM

Addendum No: 1 Project: Wolverine Power - Elmira

Service Center

Date: 2/23/21 Project No: 1807

Item 1 (BP-01 & 09): (Various Civil revisions - See revised dwgs attached)

Sheet C1.1 Demolition

Newly noted foundation along with adjacent trees surrounding the foundation will be removed by others.

Sheet C2.2 Rail Yard Site Plan

The gravel rail yard has expanded to the northeast.

Sheet C3.2 Rail Yard Grading and Drainage Plan

The additional gravel will be sloped north and northwesterly.

Sheet C4.1 Service Center Utility Plan

Septic tank was incorrectly noted as 1600 gallon. Tank is to be a 2000 gallon double compartment.

Sheet C5.1 Details

Moved storm details to this sheet to make room on Sheet C5.2 for additional information requested by health dept.

Sheet C5.2 Utility Details

Increase drain field size from 1200 sf to 1500 sf.

Changed the maximum depth of cover allowed

Referenced stone size for the drain field

Per health department, all lids are to be cast iron and are to be a minimum of 59 lbs. All lids for both the septic and holding tanks shall meet this requirement. Lids shall be 24" diameter with exception of the pump chamber which shall have a 30" diameter cover. Insulated lid on the pump chamber is no longer required.

Sheet C5.4 Fire Suppression Details

Removed the note regarding the refill rate. Refill rate of the supply well is to meet applicable fire code assuming two 30,000 gallon tanks.

Item 2 (BP-06): Light gauge framing @ canopies is included in BP-04, not this package.

Item 3 (BP-05): Exterior skin of Overhead Doors can be galvanized steel per the specification and NOT mandatory they are aluminum as noted on drawings.

Item 4 (BP-11): (Various Electrical/Data/Security revisions - See revised dwgs attached) Sheets SE1 and E2

The requirements for the pole mounted security cameras have changed. The three (3) pole mounted cameras will no longer be installed, but the rough-ins to the light poles for future security cameras will remain, including a conduit and pull string from each pole to Mechanical Room #109 for a future fiber optic cable, and 120V which will feed a pole mounted duplex receptacle at the pole's handhole. Minor panel schedule loads associated with this change are depicted on Sheet E2 in Panel #G1.

Sheets SE2 and SE3

The requirements for the pole mounted security cameras have changed. The three (3) locations remain, but the requirements for the two (2) light poles with cameras at the east have changed. Minor panel schedule loads associated with this change are depicted on Sheet SE3 in Panel #R.




Sheets E1P
The locations for exterior building mounted security cameras have changed. Instead of four (4) cameras mounted at each corner of the building, there are now nine (9) building mounted security cameras. See revised Sheet E1P for their locations.

END OF ADDENDUM #1

WOLVERINE POWER COOPERATIVE 10125 W. WATERGATE RD. CADILLAC, MI 49601

PROJECT NO.:
2018-114

EXISTING
CONDITIONS
AND
DEMOLITION
PLAN

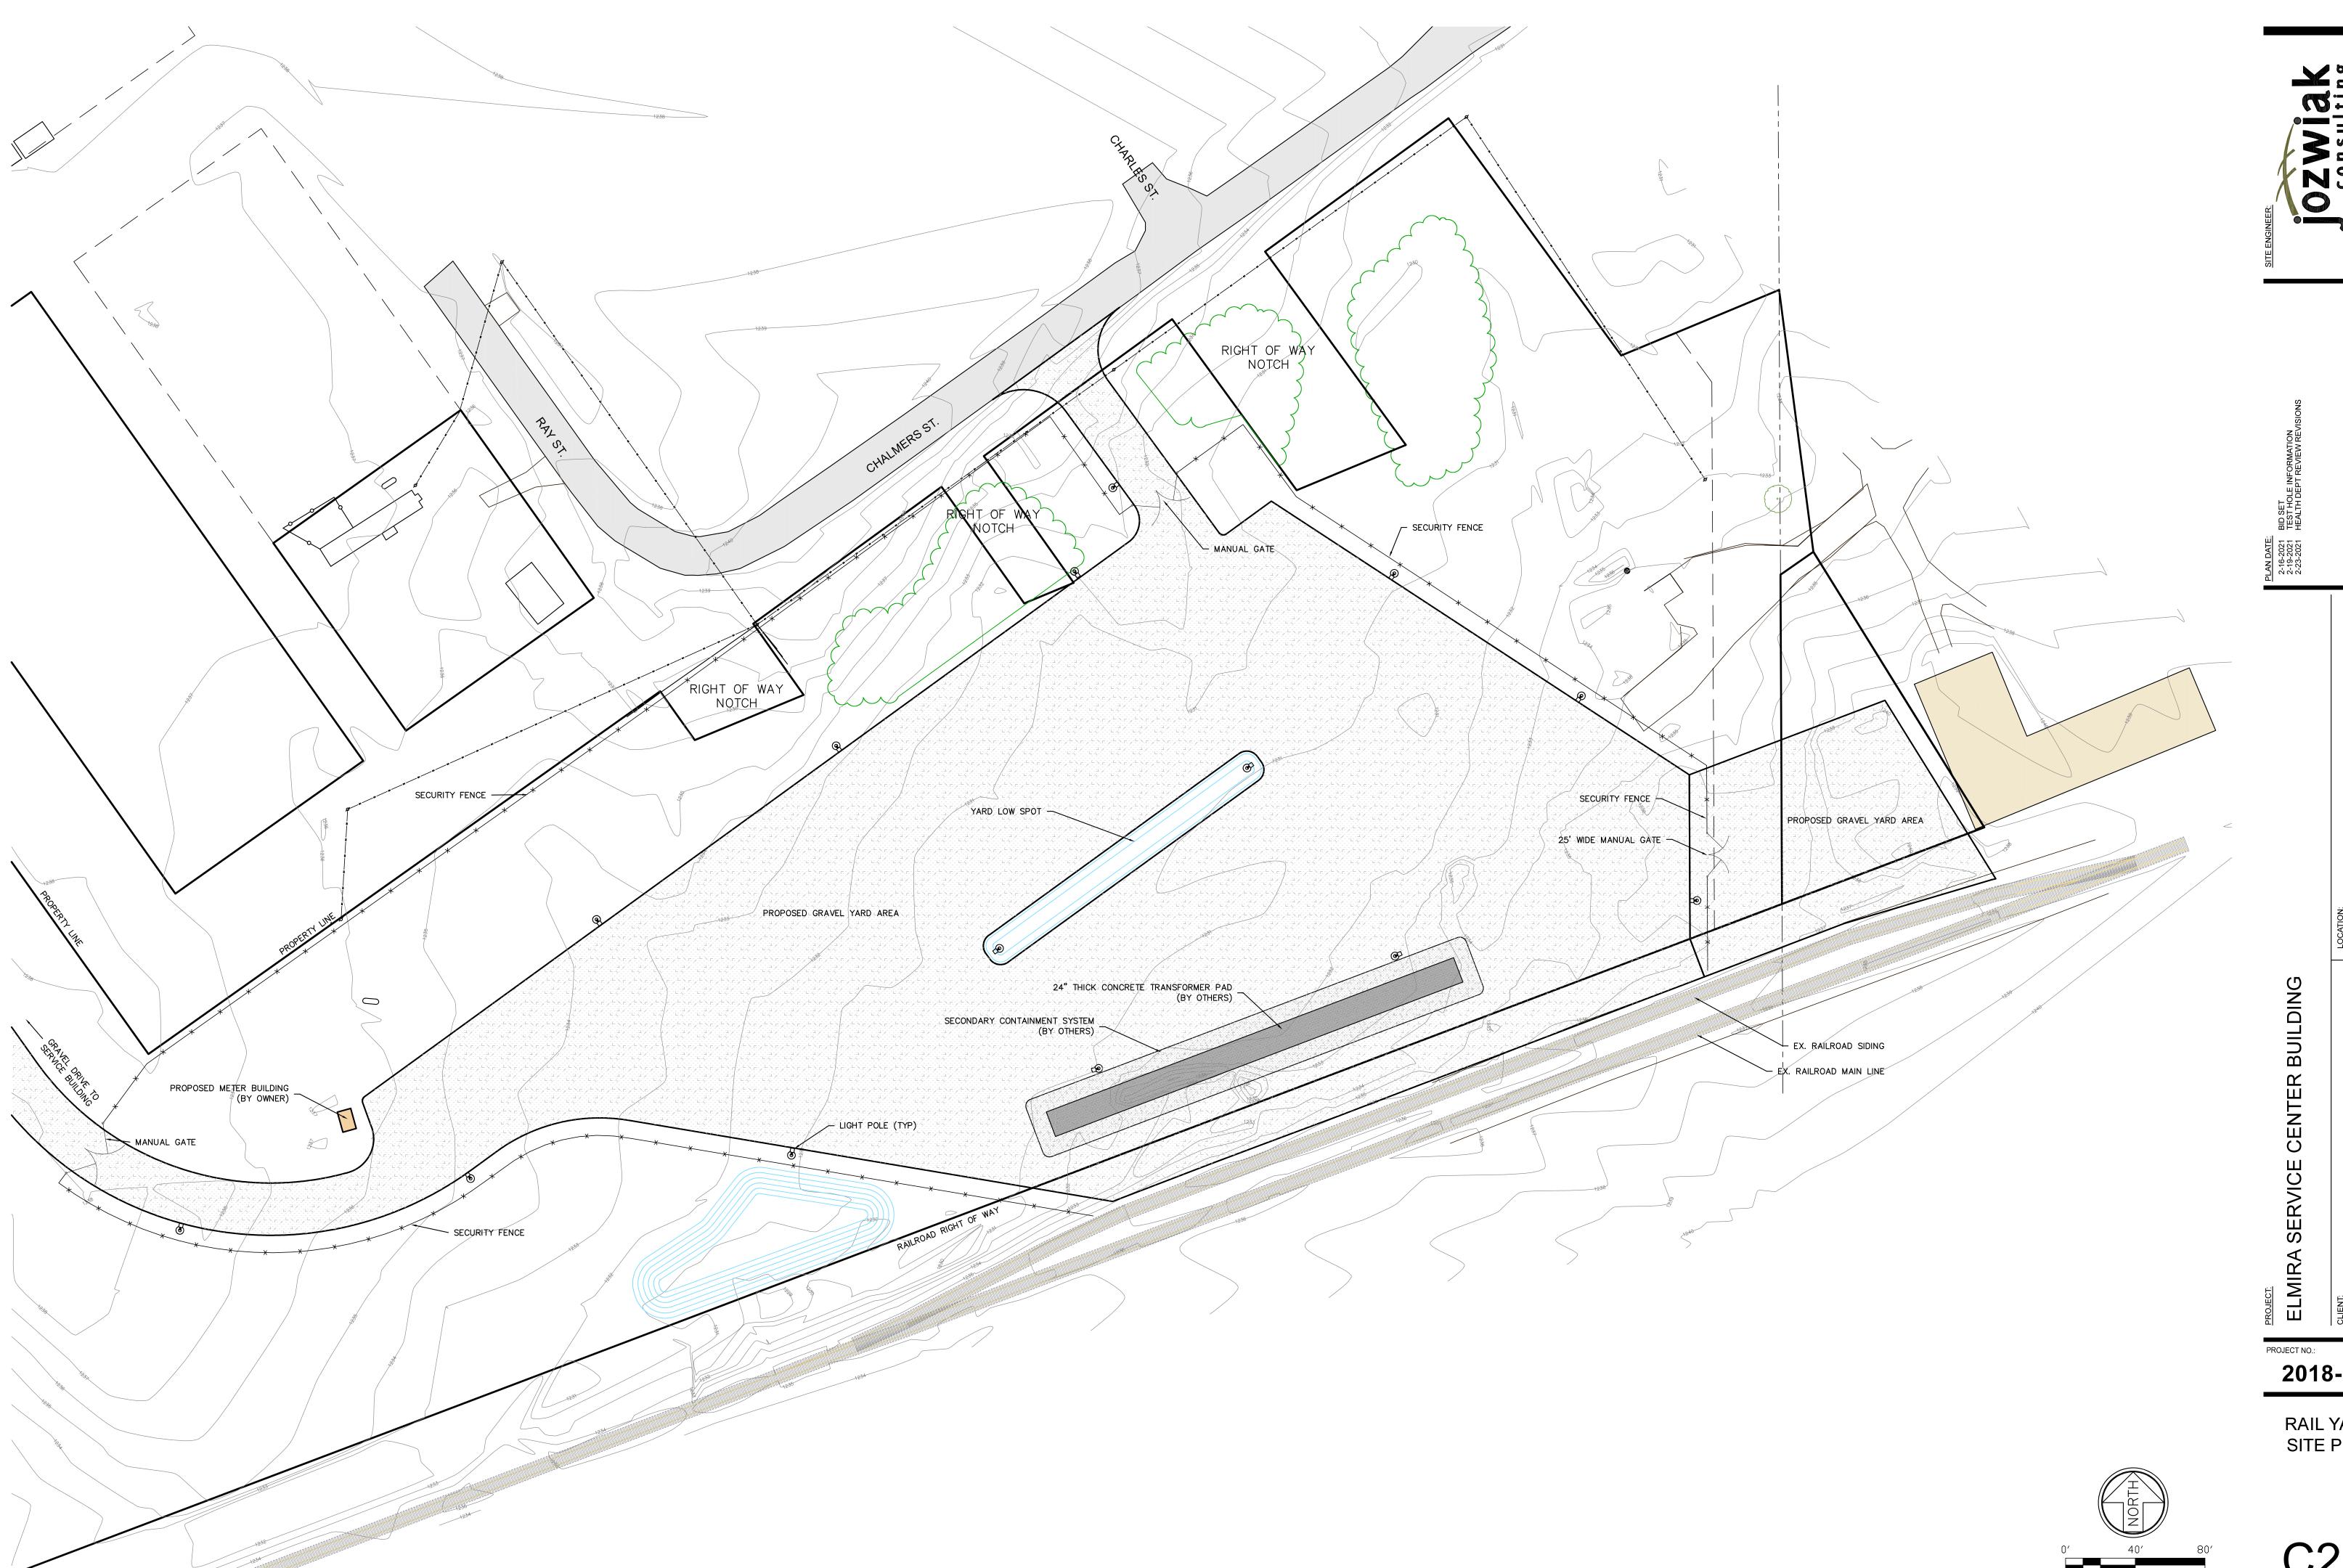






WOLVERINE POWER COOPERATIVE 10125 W. WATERGATE RD. CADILLAC, MI 49601


PROJECT NO.:
2018-114

RAIL YARD SITE PLAN

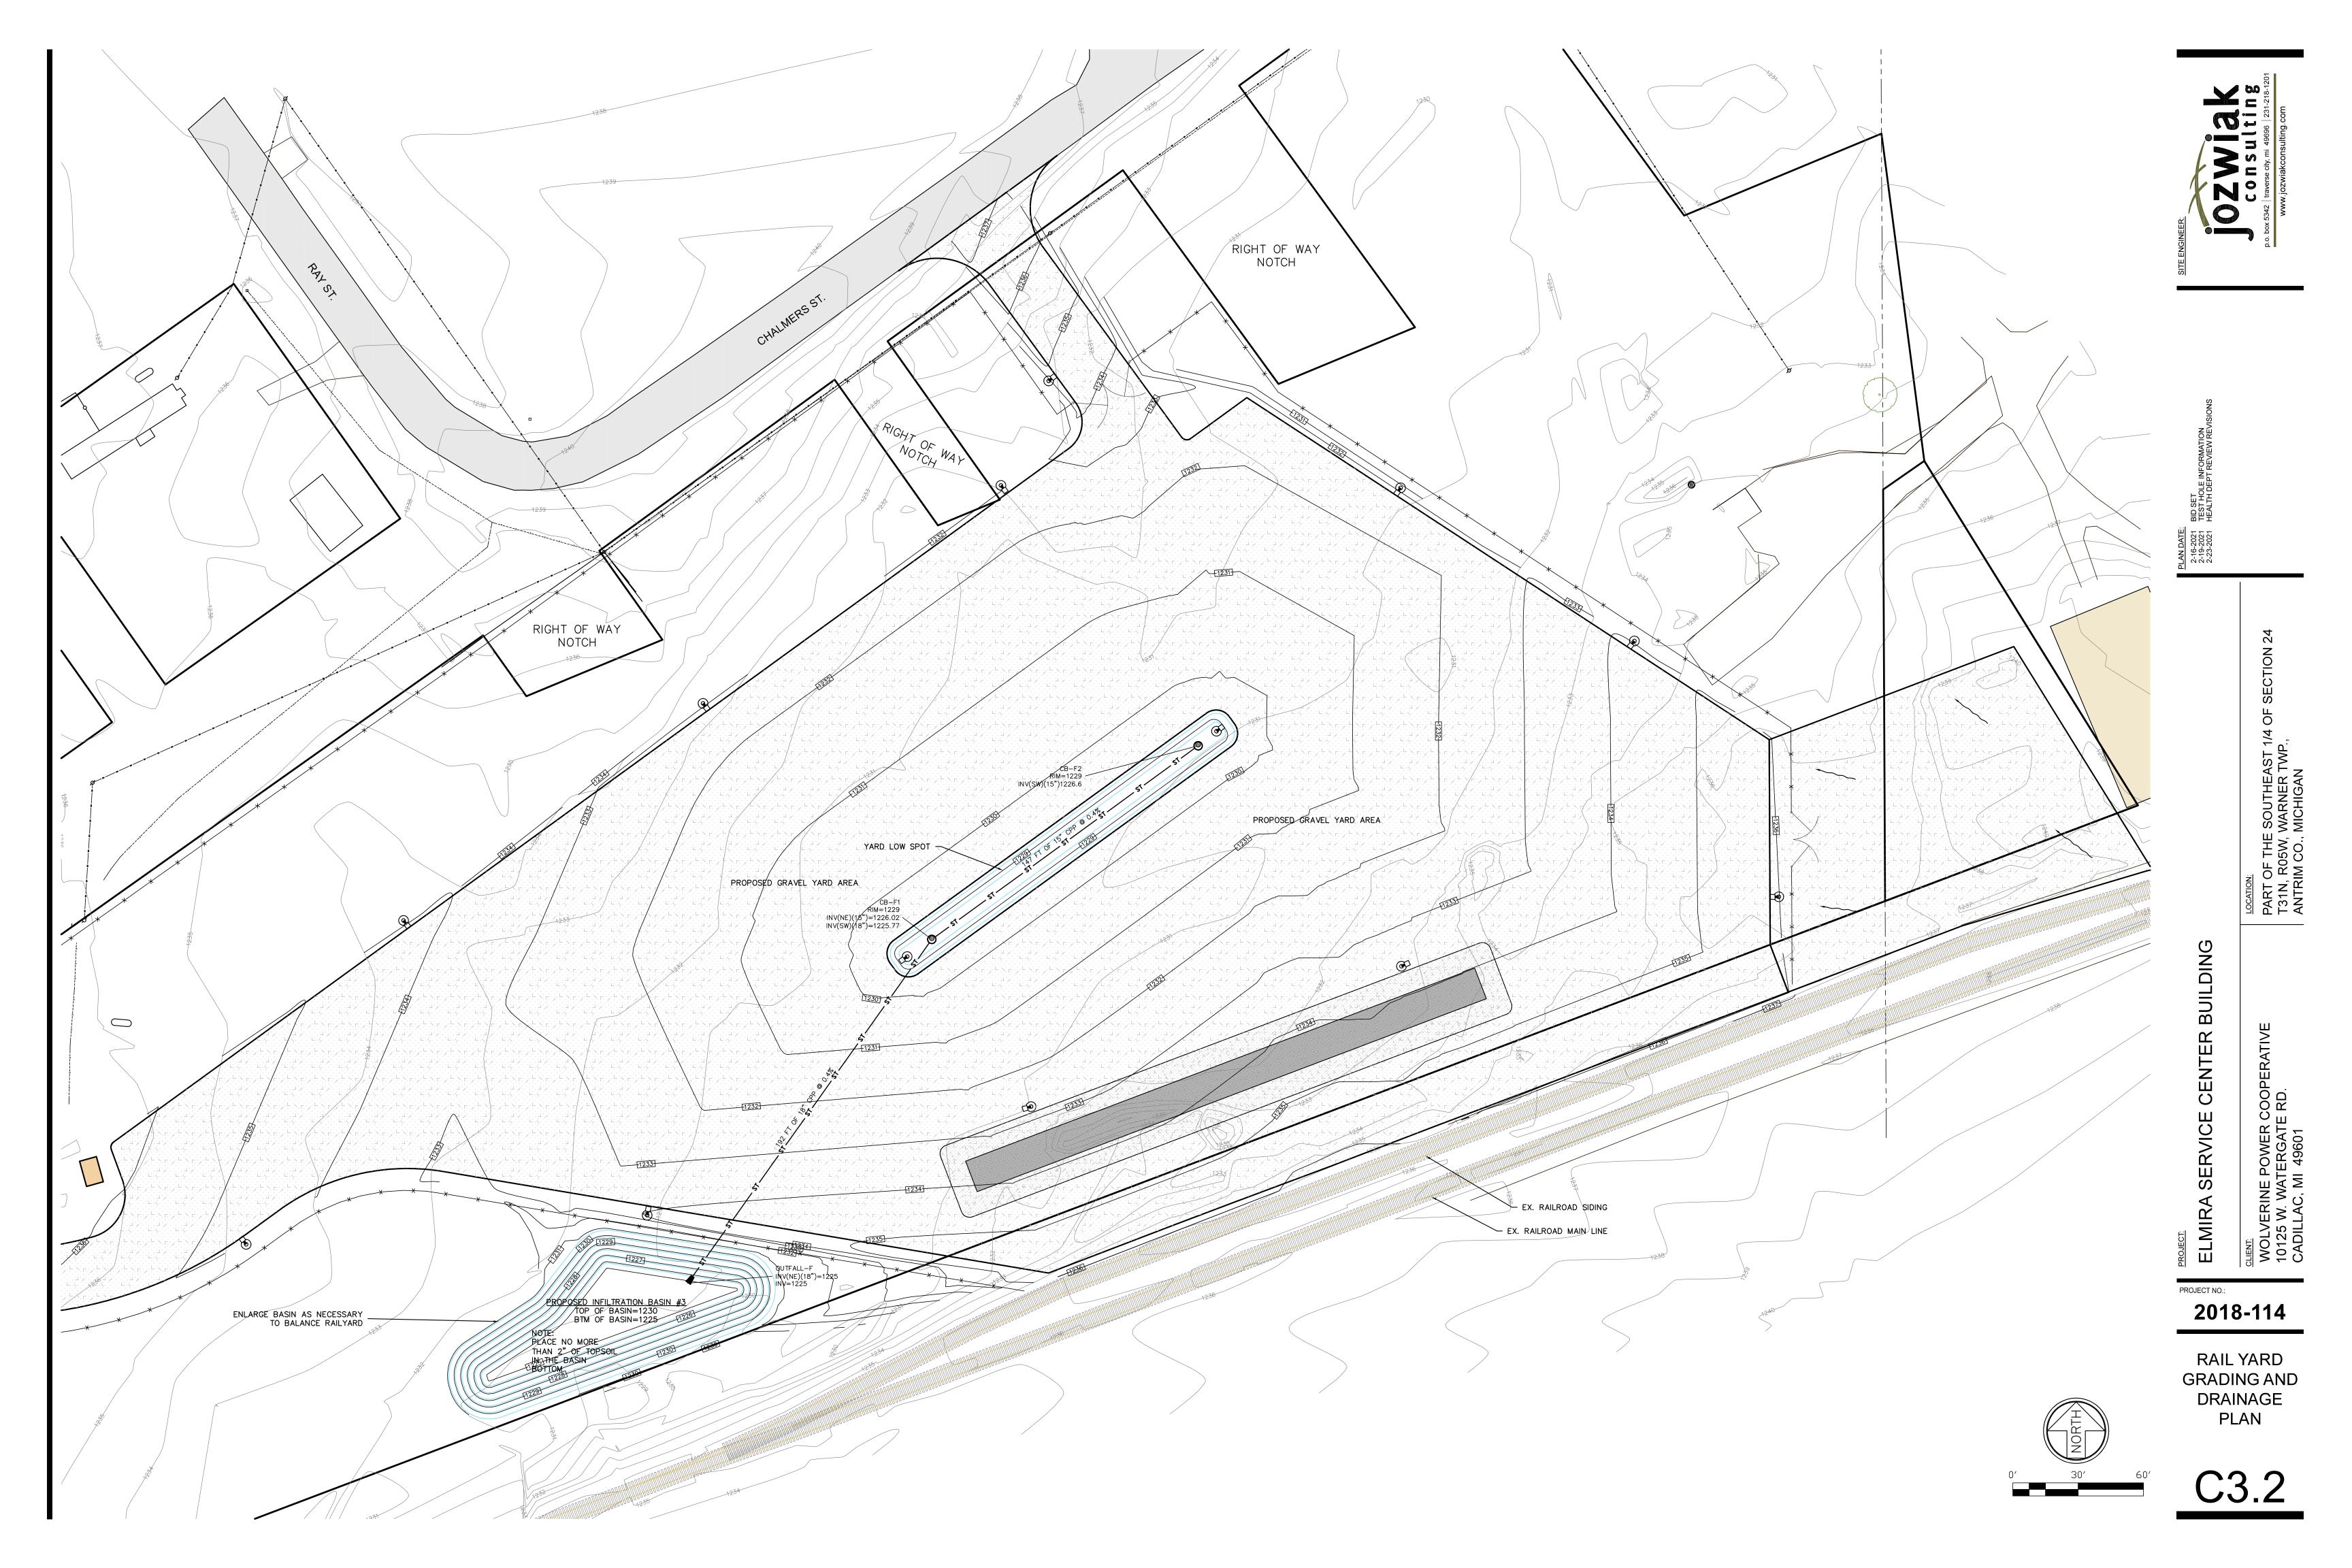

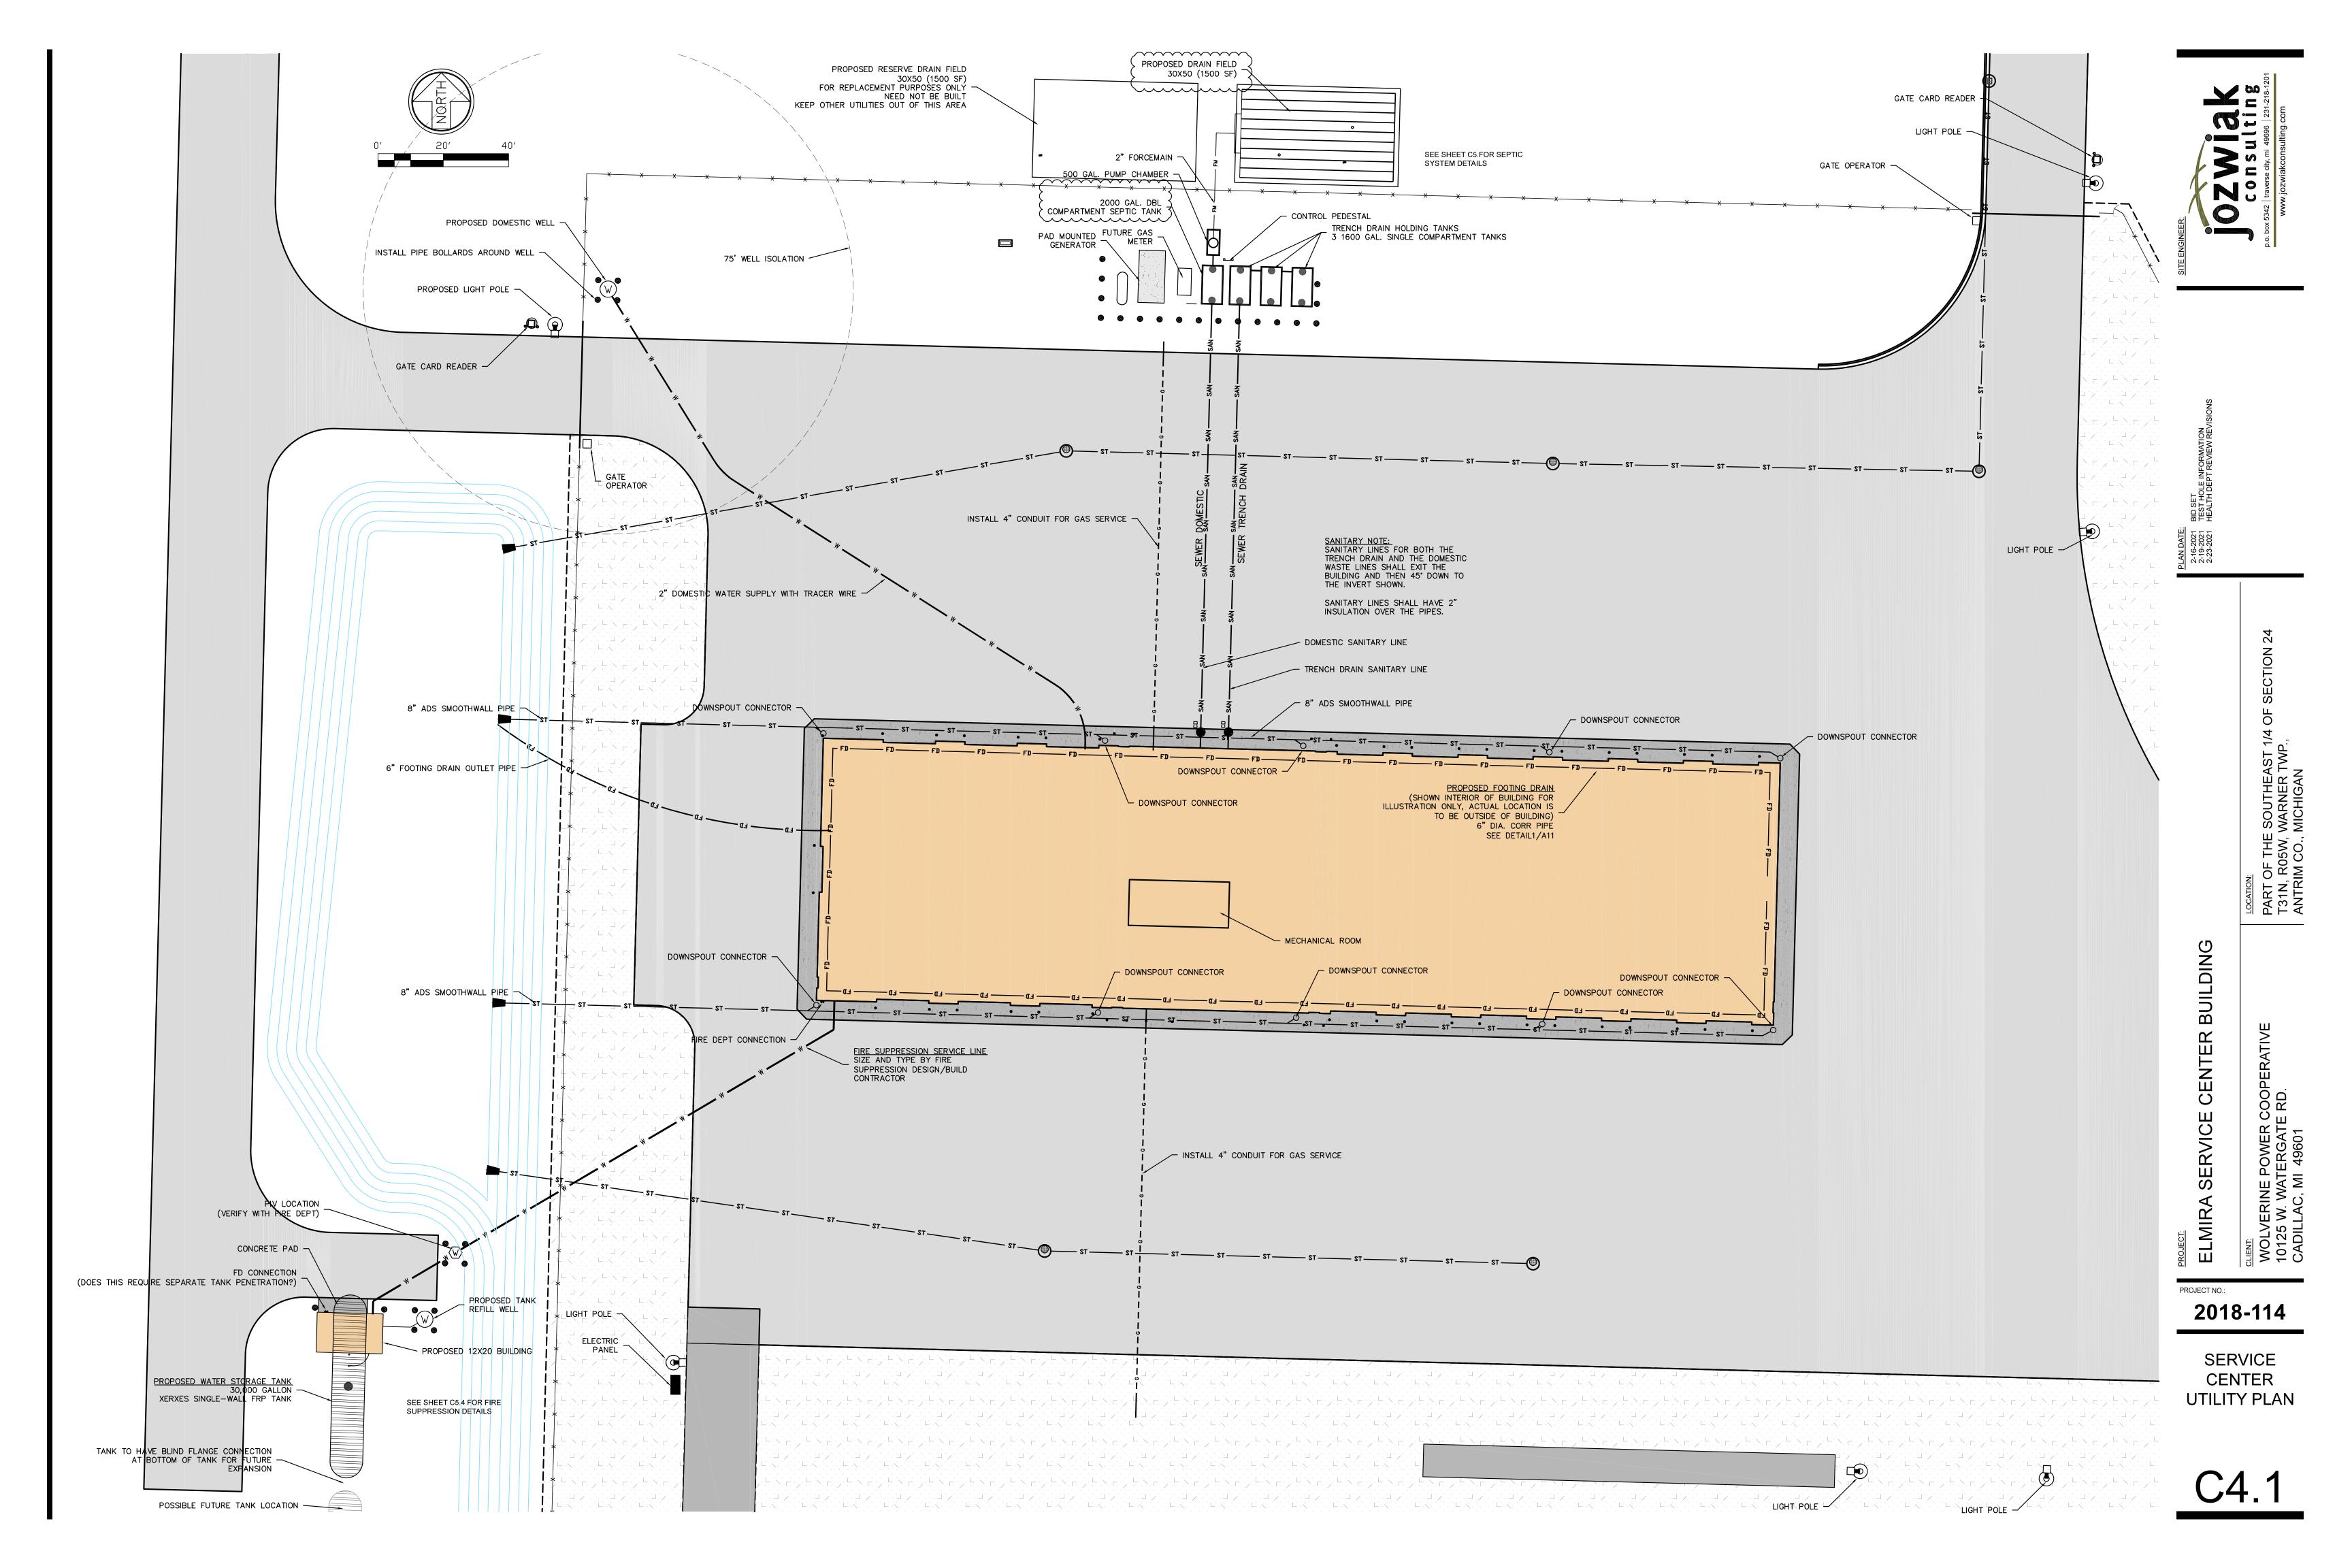

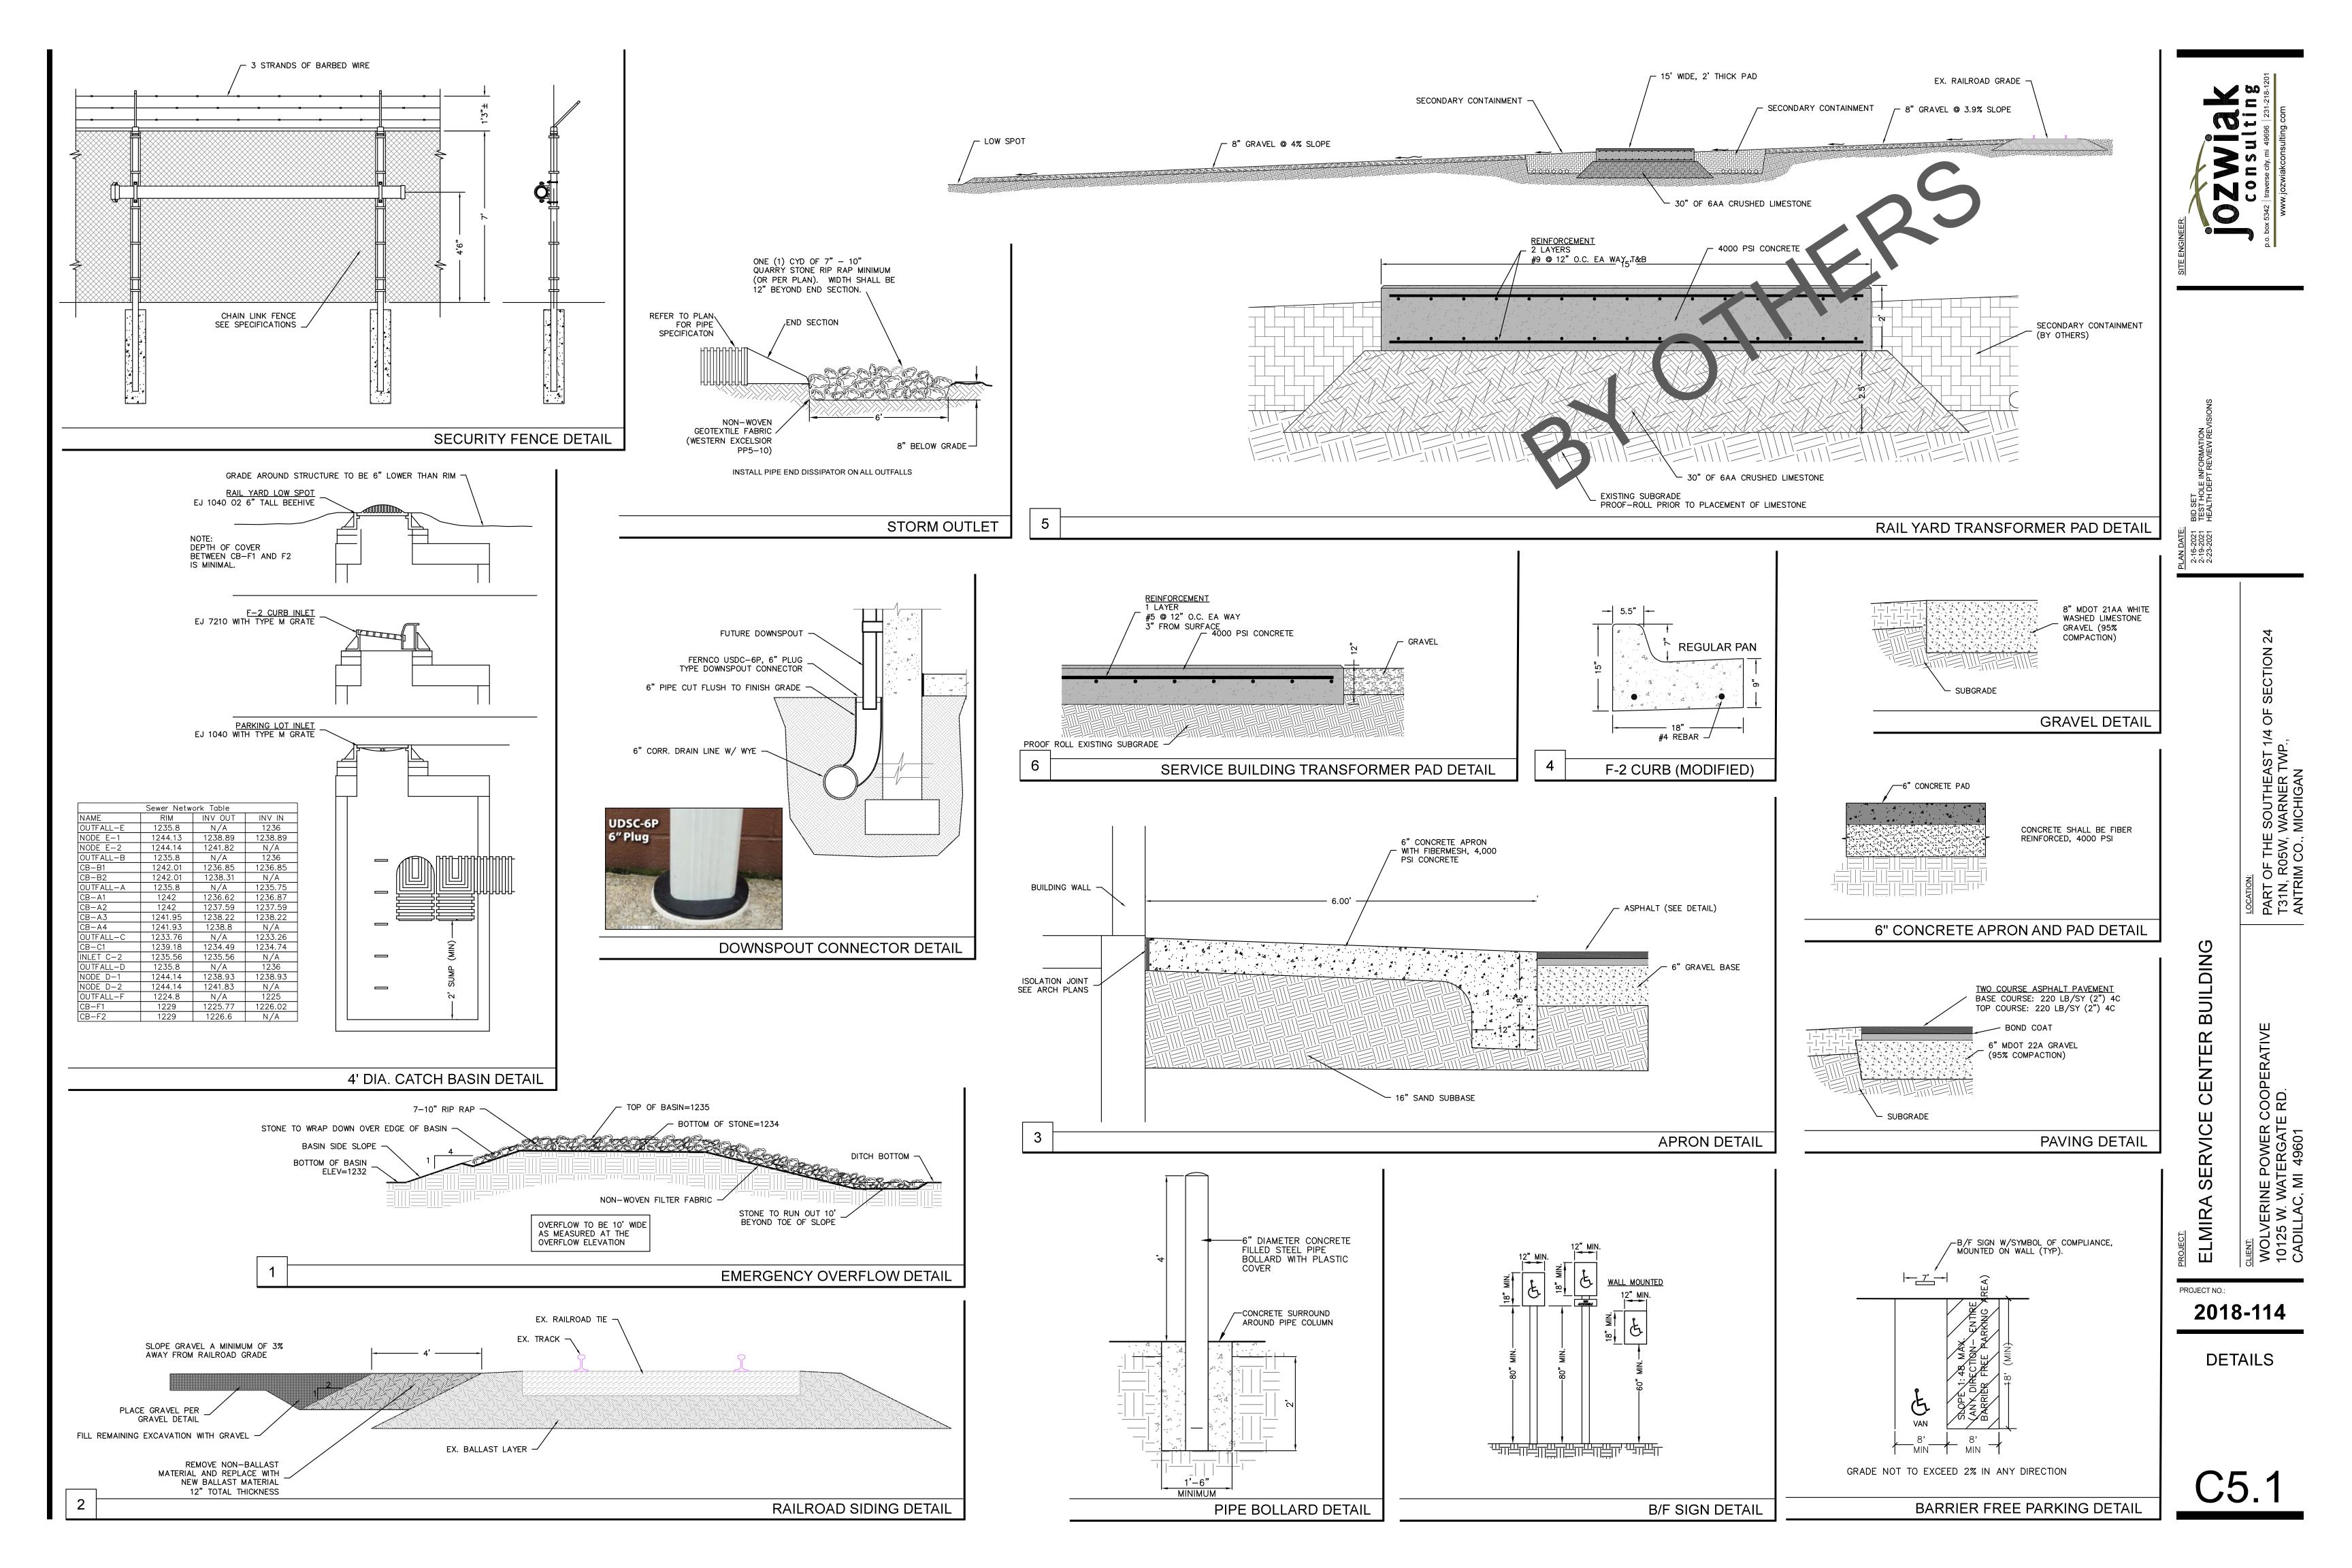

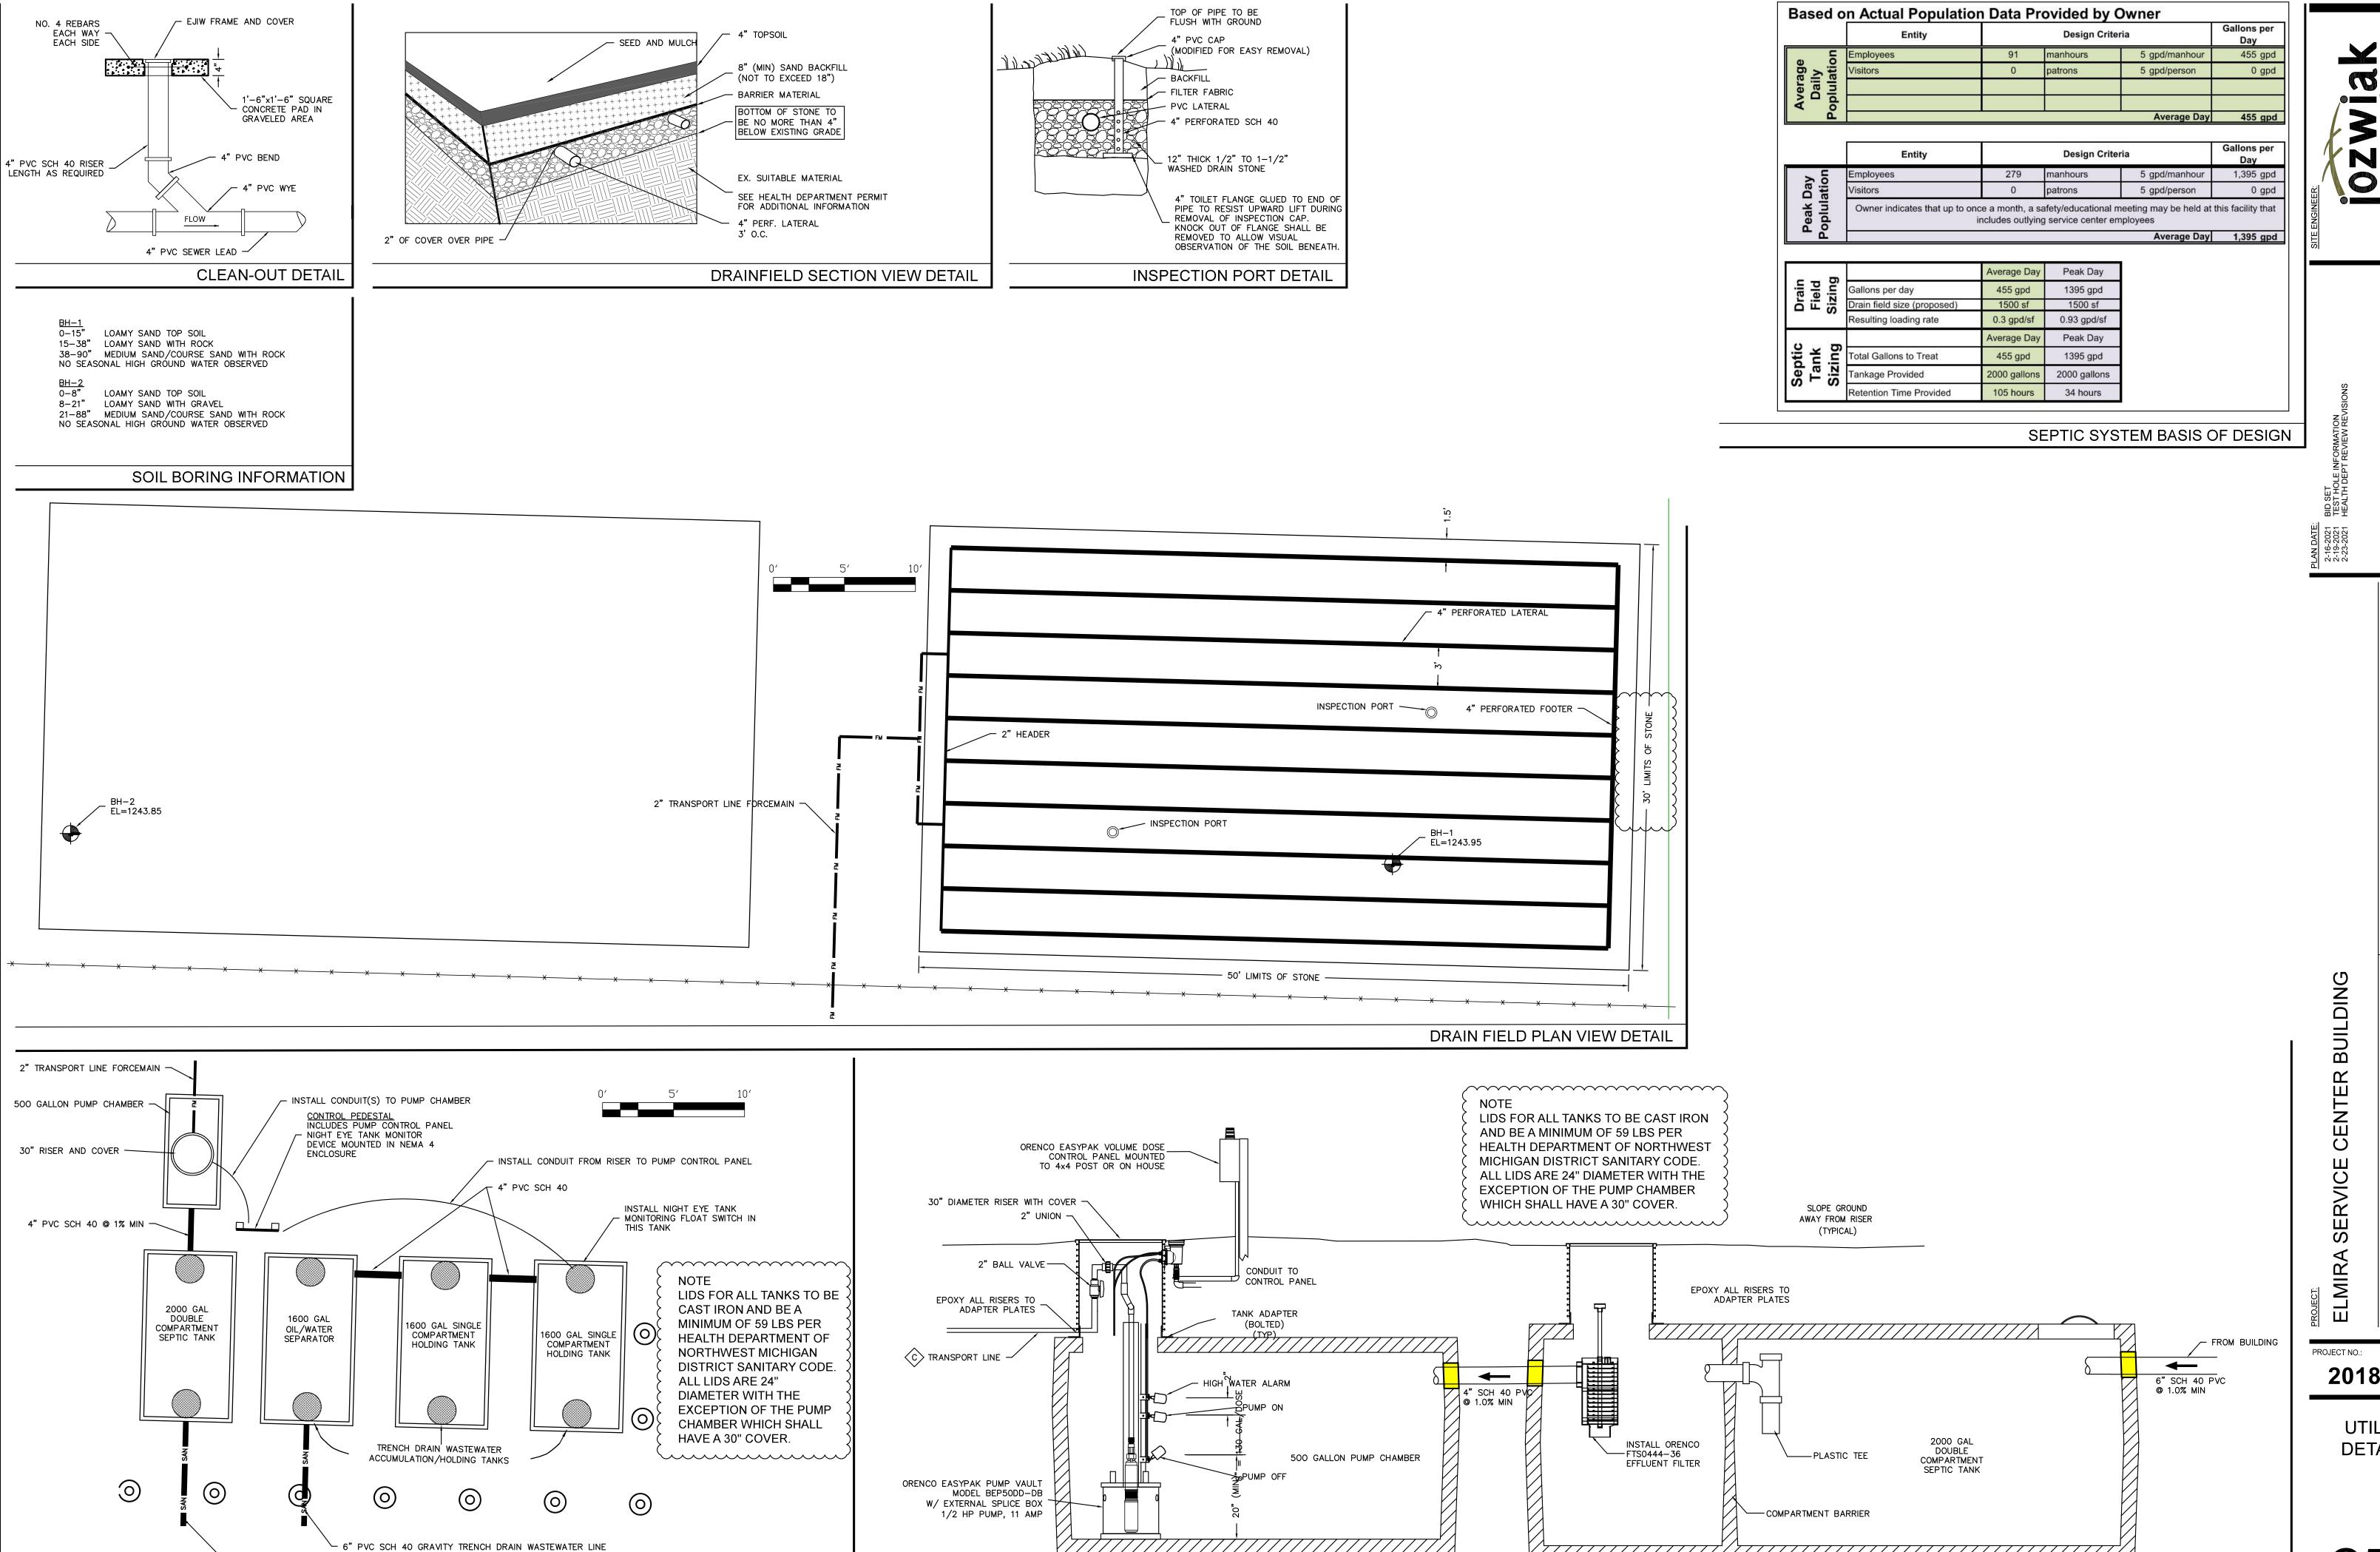

- 6" PVC SCH 40 GRAVITY DOMESTIC WASTEWATER LINE


SEPTIC TANK AND PUMP CHAMBER SECTION VIEW

65: -NS

2018-114

UTILITY **DETAILS**

SEPTIC TANK AND PUMP CHAMBER SECTION VIEW

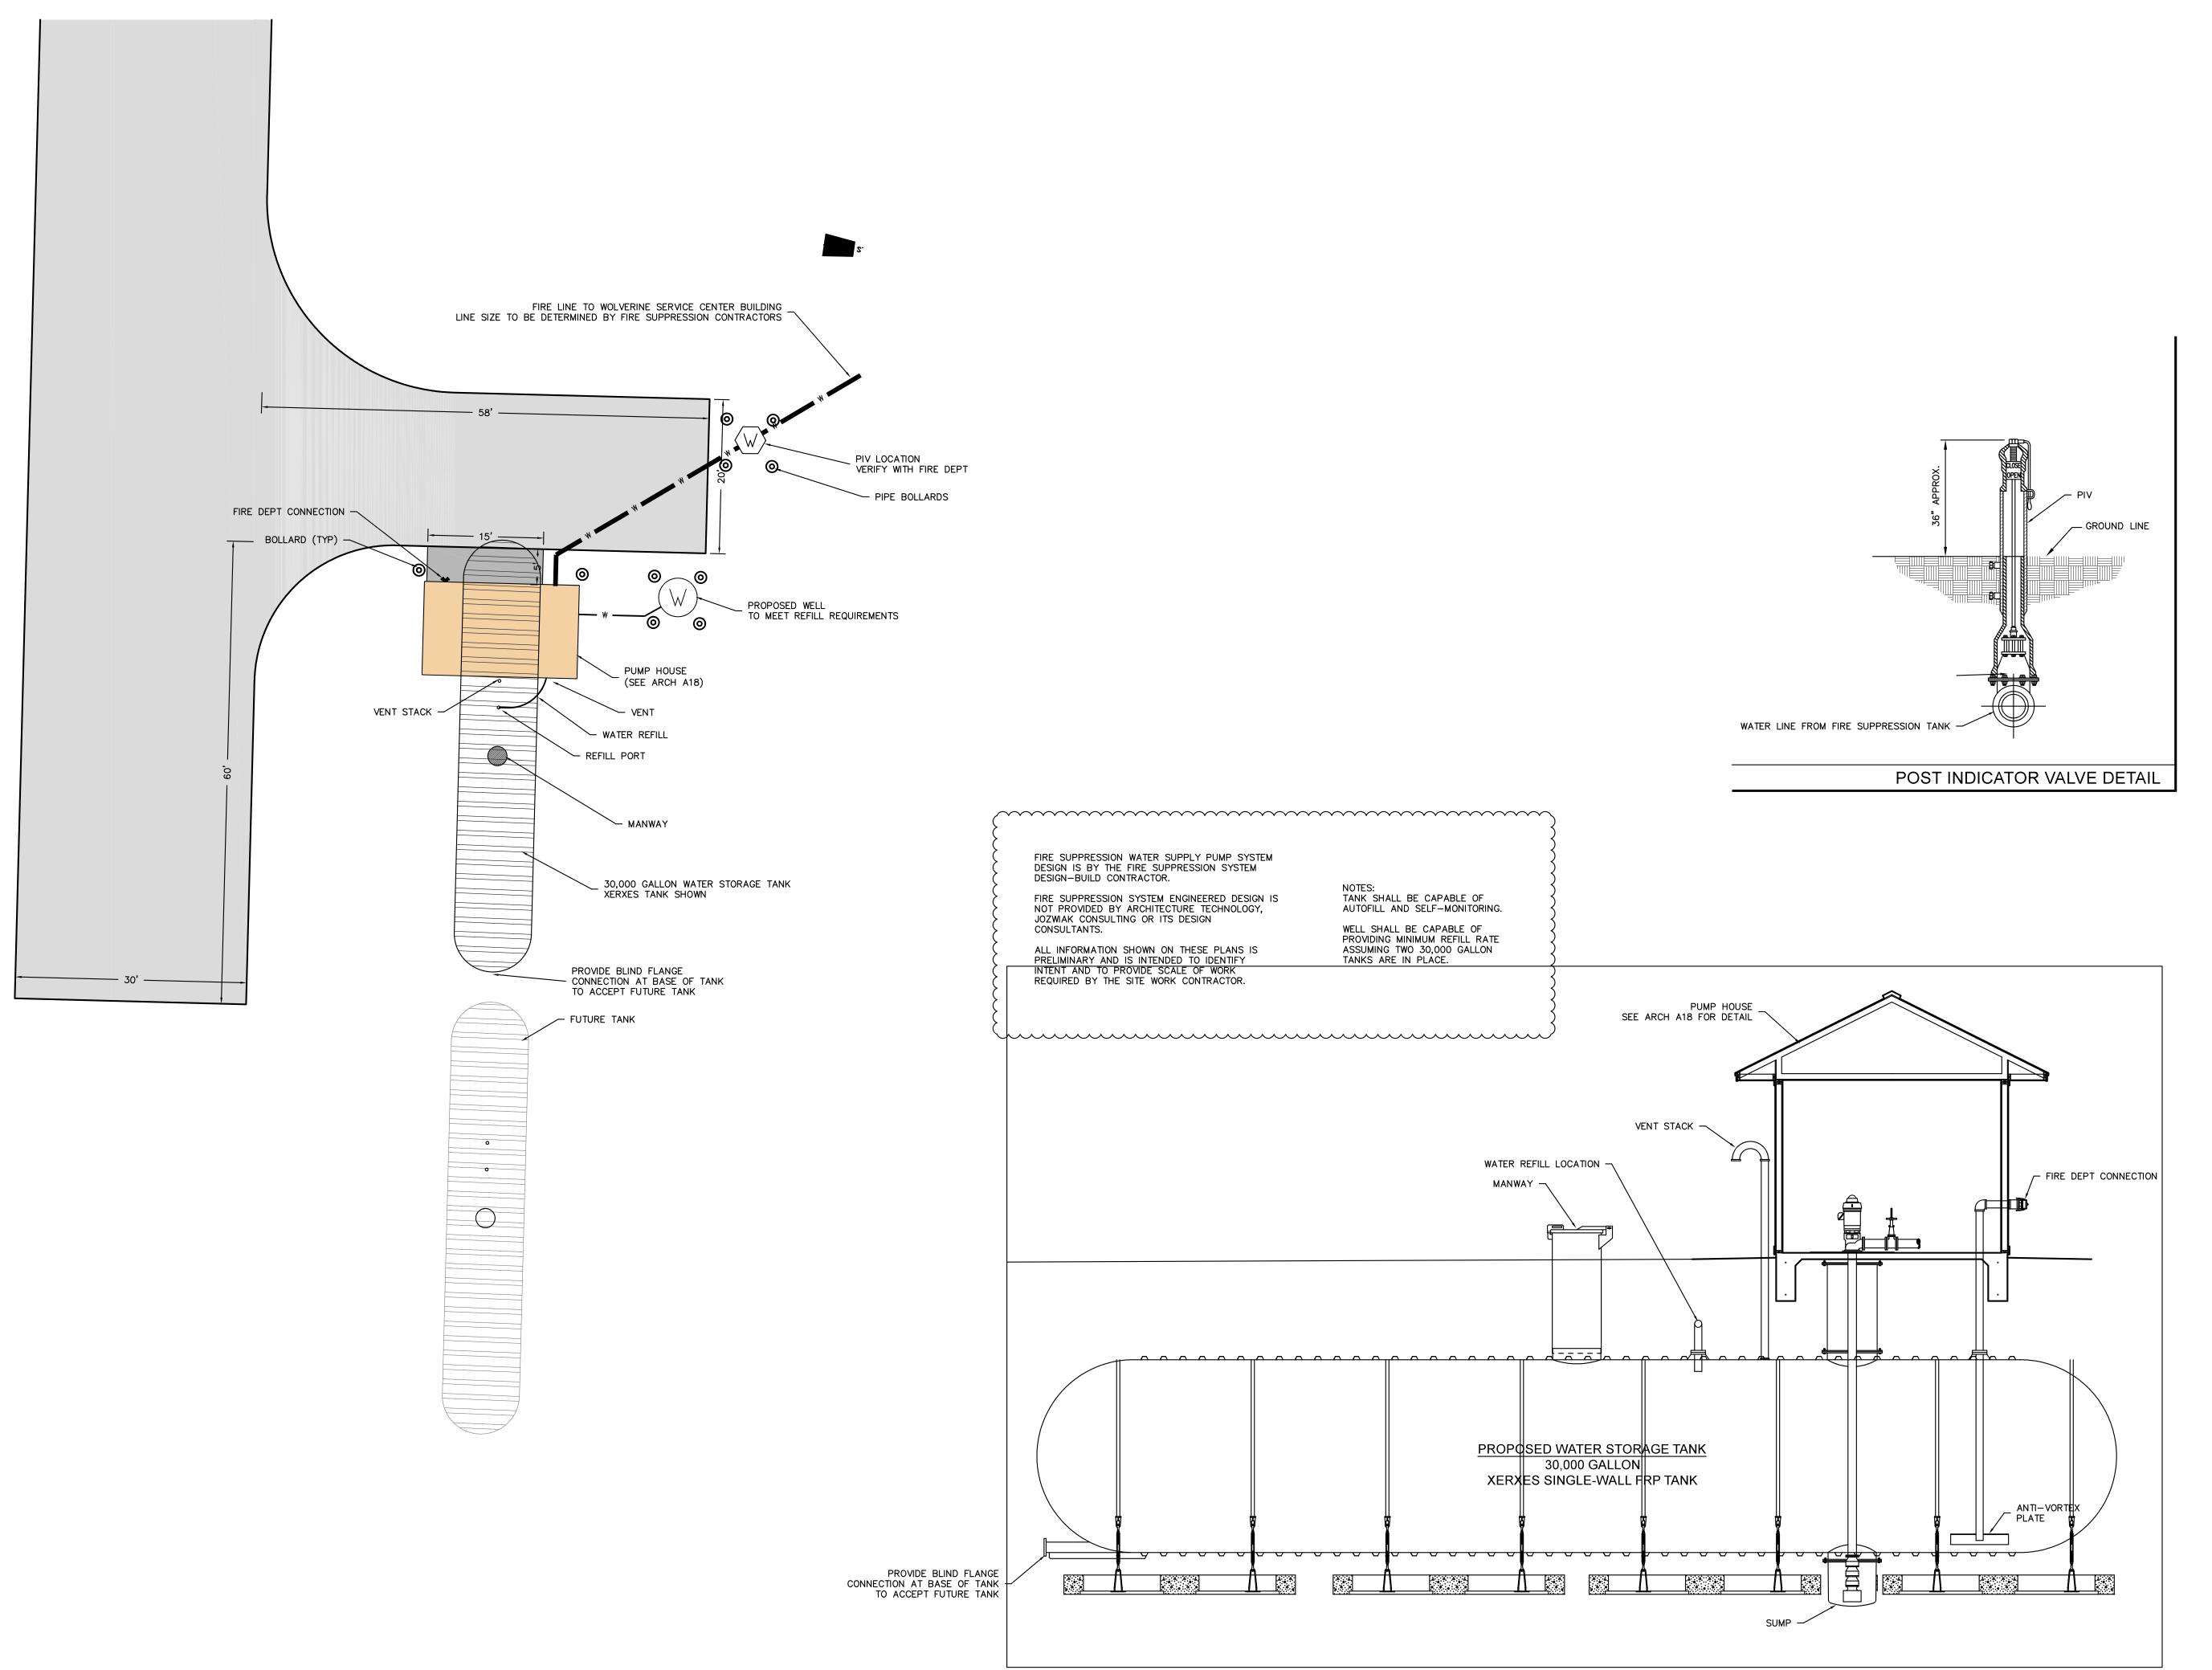


PLAN DATE: 2-16-2021 BID SET 2-19-2021 TEST HOLE INF: 2-23-2021 HEALTH DEPT F

BUILDING CENTER

WOLVERINE POWER COOPERATIV 10125 W. WATERGATE RD. CADILLAC, MI 49601 SERVICE

PROJECT NO.: 2018-114

FIRE SUPPRESSION **DETAILS**

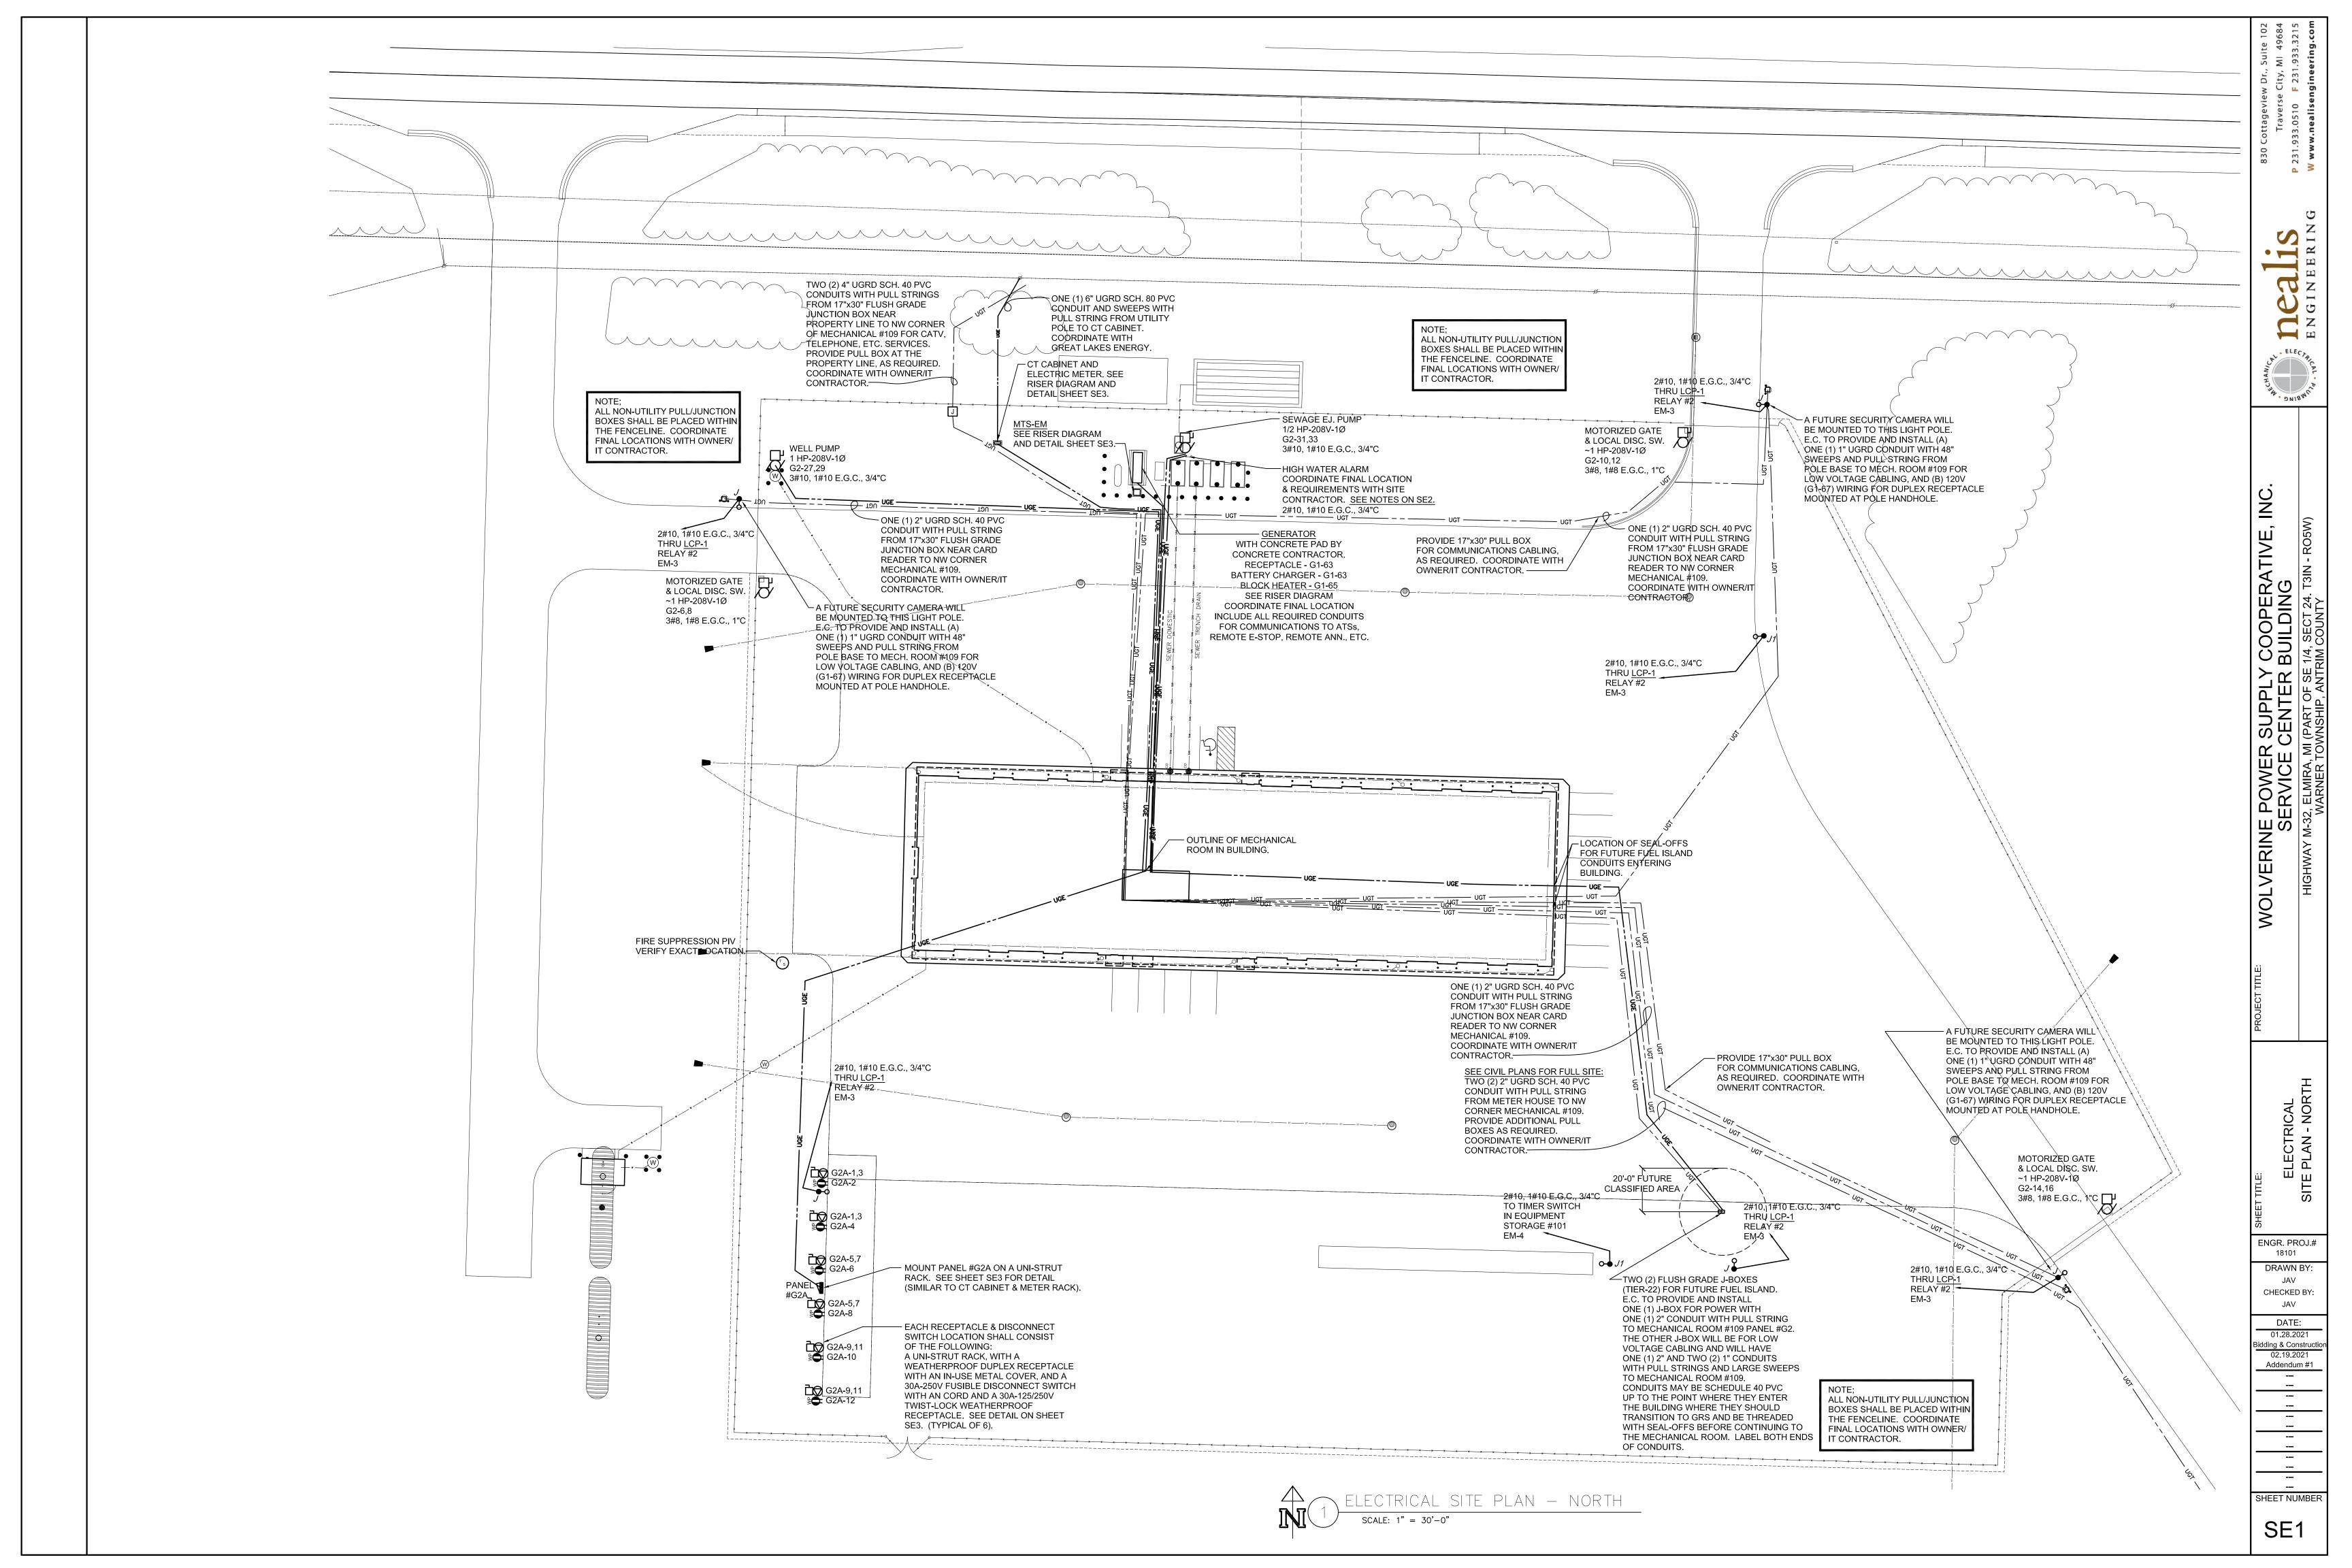

7 ^		404				400A MLO, 120/208V-3Ø-4W		
PΑ	NEL	#G1				SQ.D NQ - SURFACE MTD.		
CIR.	CB/P	DESCRIPTION	LOAD	Р	LOAD	DESCRIPTION	CB/P	CIR
1	20/1 G	OVERHEAD MOTORIZED DOOR - 101	1200	Α	540	RECEPTACLES - 114	20/1	2
3	20/1 G	OVERHEAD MOTORIZED DOOR - 101	1200	В	1500	RECEPTACLES - 114 - WASHER	20/1	4
5	20/1 G	OVERHEAD MOTORIZED DOOR - 101	1200	С	1200	RECEPTACLES - 112 - REFRIGERATOR	20/1 G	6
7	20/1 G	OVERHEAD MOTORIZED DOOR - 101	1200	Α	1800	RECEPTACLES - 112 - TOASTER OVEN	20/1	8
9	20/1 G	OVERHEAD MOTORIZED DOOR - 101	1200	В	1100	RECEPTACLES - 112 - MICROWAVE	20/1	10
11	20/1 G	OVERHEAD MOTORIZED DOOR - 101	1200	С	360	RECEPTACLES - 112 - COUNTER	20/1	12
13	20/1 G	OVERHEAD MOTORIZED DOOR - 101	1200	Α	900	RECEPTACLES - 112 SOUTH, EXTERIOR	20/1	14
15	20/1 G	OVERHEAD MOTORIZED DOOR - 101	1200	В	720	RECEPTACLES - 111	20/1	16
17	20/1 G	OVERHEAD MOTORIZED DOOR - 101	1200	С	720	RECEPTACLES - 111	20/1	18
19	20/1 G	OVERHEAD MOTORIZED DOOR - 101	1200	Α	720	RECEPTACLES - 111	20/1	20
21	20/1 G	OVERHEAD MOTORIZED DOOR - 101	1200	В	1055	RECEPTACLES - 110,111 (TV), 112 (TV)	20/1	22
23	20/1 G	OVERHEAD MOTORIZED DOOR - 101	1200	С	540	RECEPTACLES - 107,113	20/1	24
25	20/1 G	OVERHEAD MOTORIZED DOOR - 102	1200	Α	540	RECEPTACLES - 108	20/1	26
27	20/1 G	OVERHEAD MOTORIZED DOOR - 102	1200	В	1080	RECEPTACLES - 105 SOUTH	20/1	28
29		OVERHEAD MOTORIZED DOOR - 102	1200	С		RECEPTACLES - 105 SOUTH	20/1	30
31		OVERHEAD MOTORIZED DOOR - 102	1200	Α	1080	RECEPTACLES - 105 SOUTH	20/1	32
33	20/1 G	OVERHEAD MOTORIZED DOOR - 102	1200	В	720	RECEPTACLES - 105 SOUTH & NORTH	20/1	34
35		IR-4, UH-3 - 101	1314	С	720	RECEPTACLES - 105 SOUTH & NORTH	20/1	30
37		IR-3, UH-2 - 101	1314	Α	720	RECEPTACLES - 105 SOUTH & NORTH	20/1	3
39		L-2, L-3 - 101	200	В		RECEPTACLES - 104 NORTH	20/1	40
11		IR-2, IR-1, UH-1 - 102	1806	С	1080	RECEPTACLES - 104 NORTH	20/1	42
13		EF-1, L-1 - 102	1750	Α	1080	RECEPTACLES - 104 NORTH	20/1	44
15	20/1	F-1 - 109	1656	В	1080	RECEPTACLES - 104 NORTH	20/1	46
7		F-2 - 109	1219	С	900	RECEPTACLES - 104 NORTH	20/1	48
19	20/1	GWH-1, RP-1 & GC-1 - 109	800	Α	900	RECEPTACLES - 104 SOUTH	20/1	50
51		COMMUNICATIONS RACK - 109	1500	В	900	RECEPTACLES - 104 SOUTH	20/1	52
53	20/1	COMMUNICATIONS RACK - 109	1500	С	720	RECEPTACLES - 104 SOUTH	20/1	54
55		COMMUNICATIONS RACK - 109	1500	Α		RECEPTACLE - 102 - CORD REEL 138kV	50/1 G	56
57		SECURITY SYSTEM - 109	1500	В	360	RECEPTACLES - 102 - CORD REEL	20/1 G	
59		RECEPTACLES - 109	720	С	900	RECEPTACLES - 102 SOUTH	20/1 G	60
31		HIGH WATER ALARM LIGHT	300	Α	900	RECEPTACLES - 102 WEST	20/1 G	62
33		GENERATOR BATTERY CHARGER	1200	В	720	RECEPTACLES - 102 EAST	20/1 G	64
35		GENERATOR BLOCK HEATER	1500	С	540	RECEPTACLES - 102 NORTH	20/1 G	66
		POLE MOUNTED RECEPTS	450	A	1440	RECEPTACLES - 101 EAST, EXTERIOR	20/1 G	68
69		OVERHEAD MOTORIZED DOOR - 102	1200	В	900	RECEPTACLES - 101 NORTHWEST	20/1 G	
71		OVERHEAD MOTORIZED DOOR - 102	1200	С	540	RECEPTACLES - 101 WEST CENTRAL	20/1 G	7:
73		SPARE		Α	360	RECEPTACLES - 101 SOUTHWEST	20/1 G	74
75		SPARE		В	720	RECEPTACLES - 101 SOUTHWEST	20/1 G	76
77		SPARE				SPARE	20/1	78
<u>79</u>		SPARE		A		SPARE	20/1	80
31		SPACE		В		SPACE		82
83		SPACE		С		SPACE		84
,,,		OI AGE				JOI AGE		
		LIGHTS	0		VA			
		RECEPTS.	6473	5	VA	TOTAL CALCULATED		
		MOTORS	1005		VA	78.2		
		MISC	3450)	VA	217.2	Α	

PA	NEL	#EM				100A MLO, 120/208V-3Ø-4W SQ.D NQ - SURFACE MTD.		
CIR.	CB/P	DESCRIPTION	LOAD	Р	LOAD	DESCRIPTION	CB/P	CIR.
1	20/1-L	LIGHTS - EXTERIOR BLDG. MTD. (RLY 1)	1524	Α	531	EXITS & MOTION LIGHTS (#101/#102)	20/1	2
3	20/1-L	LIGHTS - POLE MOUNTED (RELAY 2)	678	В	113	LIGHT - SE POLE MTD. ON TIMER SWITCH	20/1	4
5	20/1-L	LIGHTS - #102 WEST (RLY 4)	994	С	1706	LIGHTS - 106-114	20/1	6
7	20/1-L	LIGHTS - #102 EAST & CENTER (RELAY 5)	1314	Α	1058	LIGHTS - 104, 105	20/1	8
9	20/1-L	LIGHTS - #101 WEST (RELAY 6)	1278	В	500	LIGHTING CONTROL PANEL	20/1	10
11	20/1-L	LIGHTS - #101 EAST (RELAY 7)	1278	С	1000	FIRE SUPPRESSION MONITORING	20/1	12
13	20/1	SPARE	I	Α		SPARE	20/1	14
15	20/1	SPARE	-	В		SPARE	20/1	16
17	20/1	SPARE	-	С		SPARE	20/1	18
19		SPACE		Α		SPACE		20
21		SPACE	-	В		SPACE		22
23		SPACE		С		SPACE		24
25		SPACE		Α				26
27		SPACE	I	В		SPD #EM	30/3	28
29		SPACE		С				30
		LIGHTS		.63	VA			
		RECEPTS.	0		VA	TOTAL CALCULATED		
		MOTORS	0		VA	14.6	kVA	
		MISC	1500)	VA	40.5	Α	

PA	NEL	#G2A					100A MLO, 120/208V-3Ø-4W		
CIR.		DESCRIPTION	T	LOAD	Р	LOAD	SQ.D NQ - SURFACE MTD.; NEMA 3R DESCRIPTION	CB/P	CIR.
1		RECEPTACLES - CIRCUIT		1500	Α	180	RECEPTCIRCUIT BREAKER/HEATER	20/1	2
3	GFCI	BREAKER/HEATER			В	180	RECEPTCIRCUIT BREAKER/HEATER	20/1	4
5	30/2*	RECEPTACLES -CIRCUIT		1500	С	180	RECEPTCIRCUIT BREAKER/HEATER	20/1	6
7	GFCI	BREAKER/HEATER			Α	180	RECEPTCIRCUIT BREAKER/HEATER	20/1	8
9	30/2*	RECEPTACLES -CIRCUIT		1500	В	180	RECEPTCIRCUIT BREAKER/HEATER	20/1	10
11	GFCI	BREAKER/HEATER			С	180	RECEPTCIRCUIT BREAKER/HEATER	20/1	12
13	20/1	SPARE			Α		SPARE	20/1	14
15	20/1	SPARE			В		SPARE	20/1	16
17	20/1	SPARE			С		SPARE	20/1	18
19		SPACE			Α		SPACE		20
21		SPACE			В		SPACE		22
23		SPACE			С		SPACE		24
25		SPACE			Α		SPACE		26
27		SPACE			В		SPACE		28
29		SPACE			С		SPACE		30
		LIGH	ITS	0		VA			
		RECEP	TS.	5580)	VA	TOTAL CALCULATED	LOAD:	
		MOTO	RS	0		VA	5.6	kVA	
		M	ISC	0		VA	15.5	Α	

- (A) DENOTES ARC FAULT CIRCUIT INTERRUPTER (AFCI) CIRCUIT BREAKER REQUIRED.
- B) DENOTES BREAKER LOCK REQUIRED ON CIRCUIT BREAKER.
- DENOTES 30mA GROUND FAULT EQUIPMENT PROTECTION (GFEP) CIRCUIT BREAKER REQUIRED. G) DENOTES GROUND FAULT CIRCUIT INTERRUPTER (GFCI) CIRCUIT BREAKER REQUIRED.
- (i) DENOTES CIRCUIT REQUIRED TO PASS THRU LIGHTING CONTROL PANEL.
- S) DENOTES CIRCUIT BREAKER WILL REQUIRE SHUNT-TRIP OR TO BE RUN THROUGH SHUNT-TRIP CONTACTOR. DENOTES ESTIMATED LOAD AND CIRCUIT BREAKER SIZE. E.C. SHALL CONFIRM EXACT REQUIREMENTS WITH SHOP DRAWINGS PRIOR TO ORDERING CIRCUIT BREAKERS.

\Box	NIT I	400				225A MLO, 120/208V-3Ø-4W		
<u> </u>	60/2* AIR COMPRESSOR (7.5 HP) 30/2* RECEPTACLES - (7) PRESSURE WAS GFCI (5 HP) 30/2 RECEPTACLES - DRYER GFCI (5 HP) 30/2 RECEPTACLES - LIFT #1 GFCI (7 30/2 RECEPTACLE - 105					SQ.D NQ - SURFACE MTD.		
CIR.	CB/P	DESCRIPTION	LOAD	Р	LOAD	DESCRIPTION	CB/P	CIR
1	60/2*	AIR COMPRESSOR (7.5 HP)	9200	Α	9600	RECEPTACLES - (7) WELDER	50/2	2
3				В			GFCI	4
5	30/2*	RECEPTACLES - (7) PRESSURE WASHER	4600	С	1595	MOTORIZED GATE - WEST (1 HP)	15/2	6
7	GFCI	(5 HP)		Α				8
9	30/2	RECEPTACLES - DRYER	5000	В	1595	MOTORIZED GATE - EAST (1 HP)	15/2	10
11	GFCI			С				12
13	20/2*	RECEPTACLES - LIFT #1	2200	Α	1595	MOTORIZED GATE - SOUTH (1 HP)	15/2	14
15	GFCI			В				16
17	30/2	RECEPTACLE - 105	5000	С	5425	<u>CU-1</u> - EXTERIOR	50/2	18
19				Α				20
21				В	4393	CU-2 - EXTERIOR	45/2	22
23	100/3	PANEL #G2A	5580	С				24
25				Α				26
27	15/2*	WELL PUMP (1 HP)	1664	В	2486	<u>EF-2</u> (1.5 HP)	15/3	28
29				С				30
31	15/2*	SEWAGE EJECTOR PUMP (1/2 HP)	1019	Α		SPARE	20/1	32
33				В		SPARE	20/1	34
35	20/1	SPARE		С		SPARE	20/1	36
37	20/1	SPARE		Α		SPACE		38
39	20/1	SPARE		В		SPACE		40
41		SPACE		С		SPACE		42
		LIGHTS	0		VA			
		RECEPTS.		<u>۱</u>	VA	TOTAL CALCULATED		
		MOTORS			VA	61.0		
		MISC	20971	.04	VA	169.2	A	
		IVIICO	<u> </u>		٧,١	100.2	, ,	

(A) DENOTES ARC FAULT CIRCUIT INTERRUPTER (AFCI) CIRCUIT BREAKER REQUIRED.
 (B) DENOTES BREAKER LOCK REQUIRED ON CIRCUIT BREAKER.

E) DENOTES 30mA GROUND FAULT EQUIPMENT PROTECTION (GFEP) CIRCUIT BREAKER REQUIRED.

G) DENOTES GROUND FAULT CIRCUIT INTERRUPTER (GFCI) CIRCUIT BREAKER REQUIRED.


L) DENOTES CIRCUIT REQUIRED TO PASS THRU LIGHTING CONTROL PANEL.

S) DENOTES CIRCUIT BREAKER WILL REQUIRE SHUNT-TRIP OR TO BE RUN THROUGH SHUNT-TRIP CONTACTOR.

DENOTES ESTIMATED LOAD AND CIRCUIT BREAKER SIZE. E.C. SHALL CONFIRM EXACT REQUIREMENTS WITH SHOP DRAWINGS PRIOR TO ORDERING CIRCUIT BREAKERS.

GENERATOR LOAD LIST

Location	Room	Fed From	Equipment Description	Quantity	HP	Volts	Phase	Amps	Load	Continuous/Int ermittent	Normally In Service	Step	Comments
M/DCC Flusius			LED Limbin			400	4	400.00	44000.0	0 1	V	4	
WPSC-Elmira	various		LED Lighting	40	4/0	120	1	108.33	14600.0	Cont	ı.	1	hadrada Circa mada na anatira na dalla a carra disca
WPSC-Elmira	various	G1	Overhead Motorized Door	19	1/2	120	1	9.80	22344.0	Int	Υ	2	Include five motors operating at the same time
WPSC-Elmira	various	G1	Receptacles	a lot		120	1	461.67	55400.0	Int	Y	2	Include 50% load in calculation
WPSC-Elmira	various	G1	Infrared Tube Heaters	4		120	1	2.30	1104.0	Int	Y	2	
WPSC-Elmira	various	G1	Unit Heaters	3		120	1	10.45	3762.0	Int	Y	2	
WPSC-Elmira	various	G1	Furnace	2	2/4	120	1	14.40	3456.0	Int	Y	2	
WPSC-Elmira	102	G1	Exhaust Fan 1	1	3/4	120	1	13.80	1656.0	Int	N	2	
WPSC-Elmira	various	G1	Gas Monitoring System & GWH-1	1		120	1	7.00	840.0	Int	Υ	2	
WPSC-Elmira	Generator	G1	Generator Battery Charger	1		120	1	10.00	1200.0	Cont	Y	2	
WPSC-Elmira	Mech. Rm		Air Compressor	1	7 1/2	208	1	40.00	8320.0	Int	Υ	3	
WPSC-Elmira	various	G2	pressure washer	1	5	208	1	28.00	5824.0	Int	N	3	
WPSC-Elmira	various	G2	welder	1		208	1	45.00	9360.0	Int	N	3	
WPSC-Elmira	Laundry	G2	Dryer	1		208	1	25.00	5200.0	Int	N	3	
WPSC-Elmira	102	G2	Vehicle Lift	1		208	1	11.00	2288.0	Int	N	3	
WPSC-Elmira	Site	G2	Well Pump	1	1	208	1	8.00	1664.0	Int	N	3	
WPSC-Elmira	Site	G2	Motorlized Gate	3	1	208	1	8.00	4992.0	Int	N	3	Include two motors operating at the same time
WPSC-Elmira	Site	G2	Condensing Unit 1	1		208	1	32.60	6780.8	Int	N	3	
WPSC-Elmira	Site	G2	Condensing Unit 2	1		208	1	26.40	5491.2	Int	N	3	
WPSC-Elmira	Site	G2	Receptacles - Ckt. Brkr/Heater	3		208	1	8.00	4992.0	Cont	Υ	3	
WPSC-Elmira	Site	G2	Receptacles - Ckt. Brkr/Heater	6		120	1	1.50	1080.0	Cont	Υ	3	
WPSC-Elmira	101	G2	Exhaust Fan 2	1	1 1/2	208	3	6.90	2485.8	Int	N	3	
WPSC-Elmira	Site	G2	Sewage Ejector	1	1/2	208	1	4.90	1019.2	Int	N	3	
WPSC-Elmira	Site	G2	Future Fuel Island (pumps, etc.)	2	2	208	1	50.00	10400.0	Int	N	3	
EM Amps & Load	40.53	14600.0	Step #1										
at 208V 3 phase	Amps	Watts											
G1 Amps & Load	249.15	89762.0	Ston #2										
at 208V 3 phase	249.15 Amps	Watts	Oleh #7										
at 200 v 5 phase	Allips	vvalls											
G2 Amps & Load	162.32	58477.8	Step #3										
at 208V 3 phase	Amps	Watts											
2.2001 o pridoo	,po	1.400											
Total Amps & Load	452.00	162839.8											
at 208V 3 phase	Amps	Watts											
20000													
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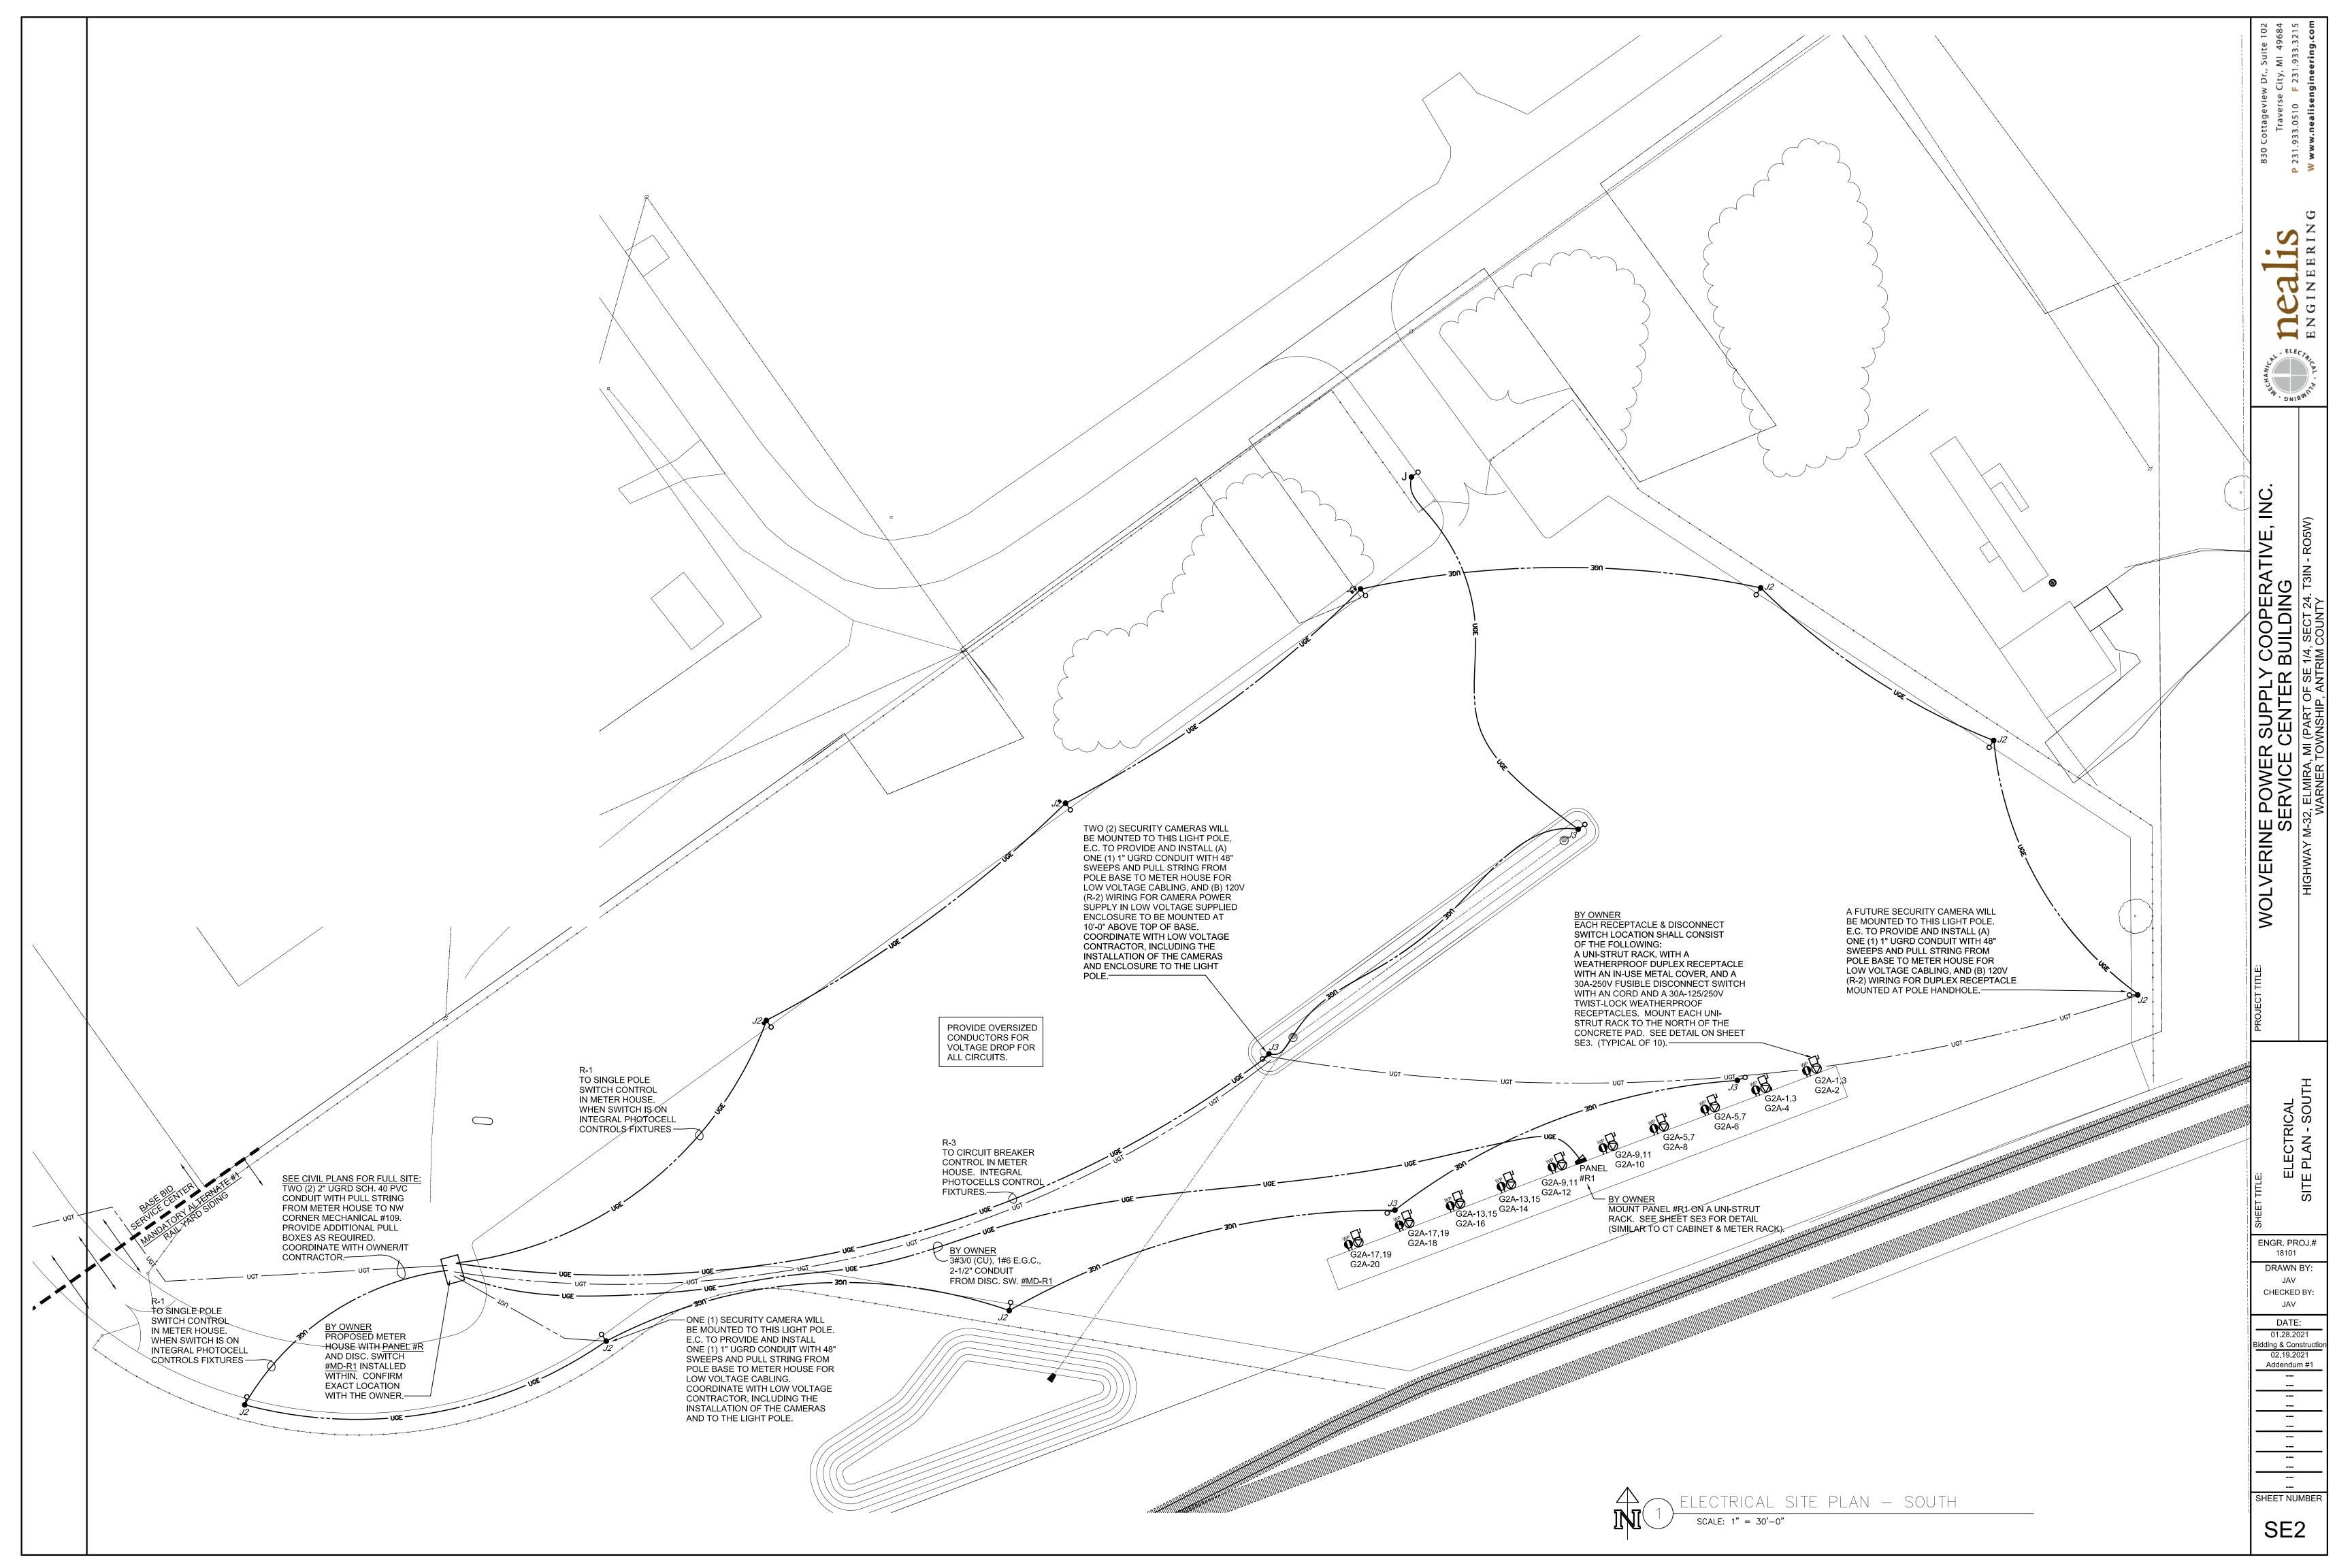


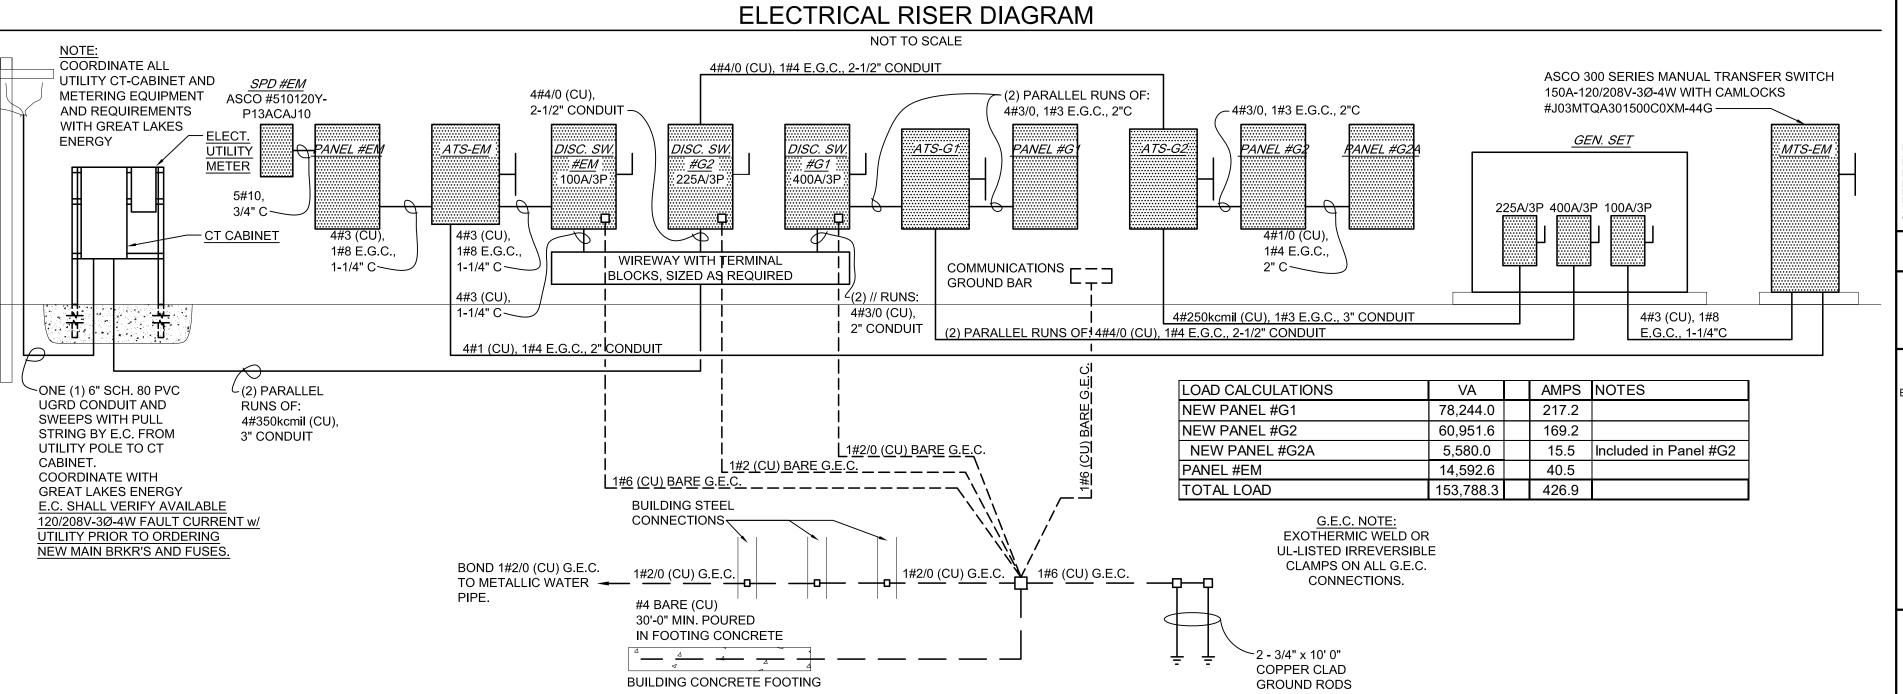

ENGR. PROJ.# 18101 DRAWN BY:

CHECKED BY: JAV DATE: 01.28.2021 idding & Construction 02.19.2021 Addendum #1

SHEET NUMBER




SITE CONTRACTOR. COORDINATE WITH THE SITE CONTRACTOR.

BY OWNER

РΔ	NEL	#R				200A MCB, 120/240V-1Ø-3W		
1 / \			T			SQ.D NQ - SURFACE MTD.		
CIR.	CB/P	DESCRIPTION	LOAD	Р	LOAD	DESCRIPTION	CB/P	CII
1	20/1	YARD LIGHTING - SWITCHED	1243	Α	450	SECURITY CAMERAS / POLE MTD. RECEP	20/1	2
3	20/1	YARD LIGHTING - AUTO	339	В		SPARE	20/1	4
5	20/1	LIGHTS - METER HOUSE		Α		SPARE	20/1	6
7	20/1	RECEPTACLES - METER HOUSE		В		SPARE	20/1	8
9	20/1	SPARE		Α		SPACE		1
11	20/1	SPARE		В		SPACE		1
13		SPACE		Α		SPACE		1
15		SPACE		В		SPACE		1
17		SPACE		Α		SPACE		1
19		SPACE		В		SPACE		2
21		SPACE		Α		SPACE		2
23		SPACE		В		SPACE		2
25		SPACE		Α		SPACE		2
27		SPACE		В		SPACE		2
29		SPACE		Α		SPACE		3
		LIGHTS	1977	.5	VA			-
		RECEPTS.	450		VA	TOTAL CALCULATED	LOAD:	
		MOTORS	0		VA	2.4	kVA	
		MISC	0		VA	10.1	Α	

	N 1 - 1	#D4					200A MCB, 120/240V-1Ø-3W		
PA	NEL	. #R1					SQ.D NQ - SURFACE MTD.; NEMA 3R		
CIR.	CB/P	DESCRIPTION		LOAD	Р	LOAD	DESCRIPTION	CB/P	CIF
1	30/2*	RECEPTACLES - CIRCUIT		1500	Α	180	RECEPTCIRCUIT BREAKER/HEATER	20/1	2
3	GFCI	BREAKER/HEATER			В	180	RECEPTCIRCUIT BREAKER/HEATER	20/1	4
5	30/2*	RECEPTACLES -CIRCUIT		1500	Α	180	RECEPTCIRCUIT BREAKER/HEATER	20/1	6
7	GFCI	BREAKER/HEATER			В	180	RECEPTCIRCUIT BREAKER/HEATER	20/1	8
9	30/2*	RECEPTACLES -CIRCUIT		1500	Α	180	RECEPTCIRCUIT BREAKER/HEATER	20/1	10
11	GFCI	BREAKER/HEATER			В	180	RECEPTCIRCUIT BREAKER/HEATER	20/1	12
13	30/2*	RECEPTACLES -CIRCUIT		1500	Α	180	RECEPTCIRCUIT BREAKER/HEATER	20/1	14
15	GFCI	BREAKER/HEATER			В	180	RECEPTCIRCUIT BREAKER/HEATER	20/1	16
17	30/2*	RECEPTACLES -CIRCUIT		1500	Α	180	RECEPTCIRCUIT BREAKER/HEATER	20/1	18
19	GFCI	BREAKER/HEATER			В	180	RECEPTCIRCUIT BREAKER/HEATER	20/1	20
21		SPACE			Α		SPACE		22
23		SPACE			В		SPACE		24
25		SPACE			Α		SPACE		26
27	-	SPACE			В		SPACE		28
29		SPACE			Α		SPACE		30
			LIGHTS	0		VA			
			RECEPTS.	9300)	VA	TOTAL CALCULATED	-	
			MOTORS	0		VA	9.3		
			MISC	0		VA	38.8	Α	

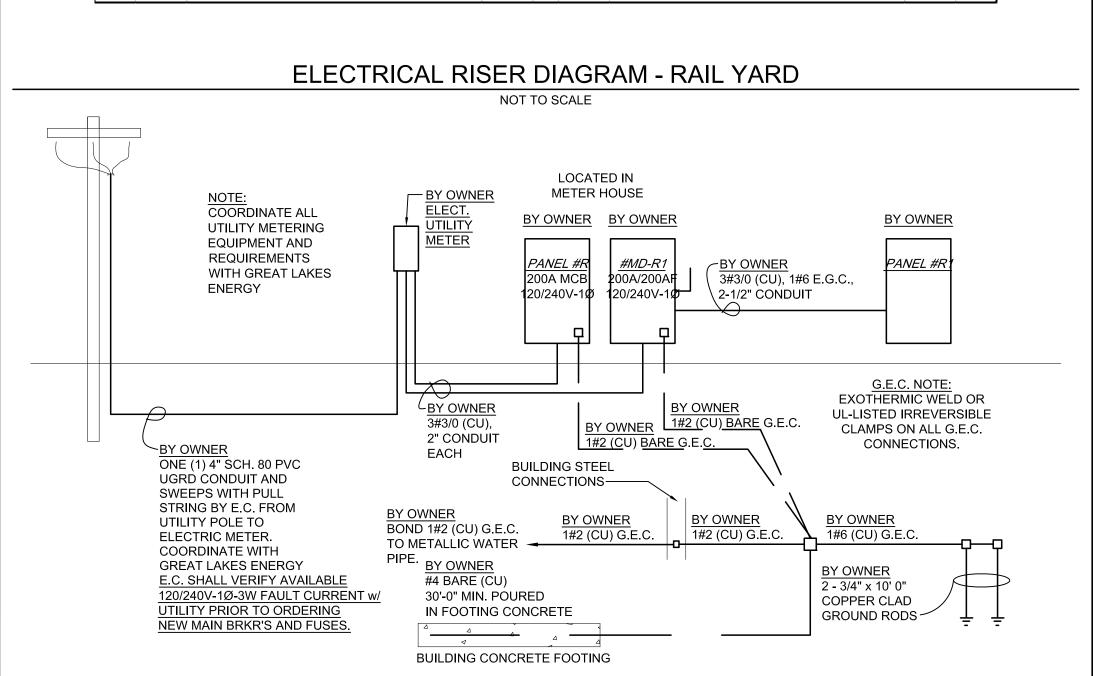

NOTES:


- 1. PROPOSED FLUSH-GRADE JUNCTION BOX IN UNPAVED AREAS SHALL BE STANDARD JUNCTION BOX QUAZITE #PT1730BA18, 17"x30" POLYMER CONCRETE BOX WITH OPEN BOTTOM, UL-LISTED, TIER-8 APPLICATION, AND STANDARD GREY FINISH AND #PT1730CA0012 STANDARD COVER WITH 'COMMUNICATIONS' LABEL, OR #PT1730CA0017 STANDARD COVER WITH 'ELECTRIC' LABEL. JUNCTION BOXES SHALL BE PROVIDED WHERE NECESSARY, FOR EASE OF CONDUCTOR PULLING, TO LIMIT THE NUMBER OF CONDUIT BENDS TO LESS THAN 360°, ETC JUNCTION BOXES SHALL BE PLACED IN UNPAVED AREAS AND INSIDE THE FENCED AREA. PROVIDE TIER-22 COVERS FOR GRAVEL AREAS.
- 2. ALL SITE COMMUNICATIONS CONDUITS SHALL BE PROVIDED WITH 48" SWEEPS.

EXTERIOR LIGHTING CONTROL: SEQUENCE OF OPERATIONS


- 1. <u>AUTOMATIC ON:</u> LUMINAIRES TO TURN ON VIA INTEGRATED PHOTOCELLS WHEN NATURAL LIGHT LEVELS DROP BELOW A
- PRE-PROGRAMMED LEVEL. 2. PARTIAL OFF: LUMINAIRES TO REDUCE TO 50% OUTPUT VIA INTEGRATED MOTION DETECTORS AFTER THIRTY (30) MINUTES OF INACTIVITY.
- 3. AUTOMATIC FULL OFF: LUMINAIRES TO TURN OFF VIA INTEGRATED PHOTOCELLS WHEN NATURAL LIGHT LEVELS EXCEED A PRE-PROGRAMMED LEVEL.

TYPE "J", "J1", "J2" & "J3" LIGHT FIXTURE & CONCRETE BASE DETAIL


NO SCALE PROVIDE FLUSH GRADE JUNCTION BOX AT BASE OF POLE, AS REQUIRED.

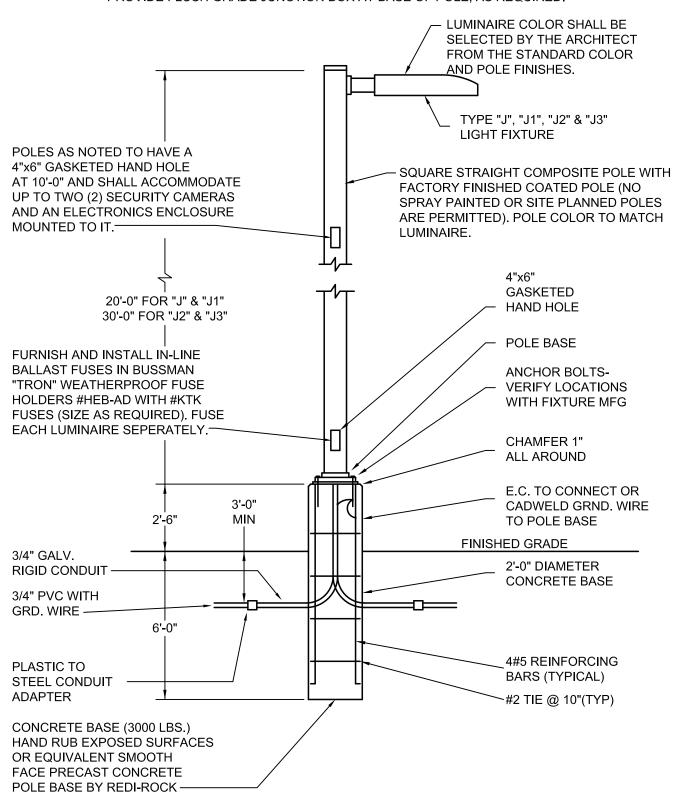


ELECTRICAL EQUIPMENT & GENERATOR CONCRETE PAD DETAILS

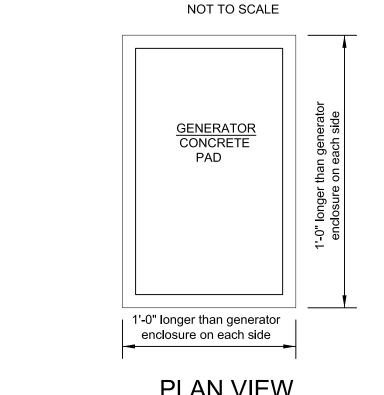


PLAN VIEW

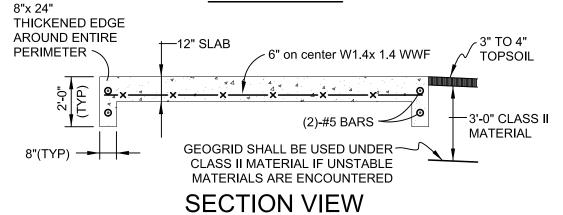


ELECTRICAL CT CABINET & METER DETAIL

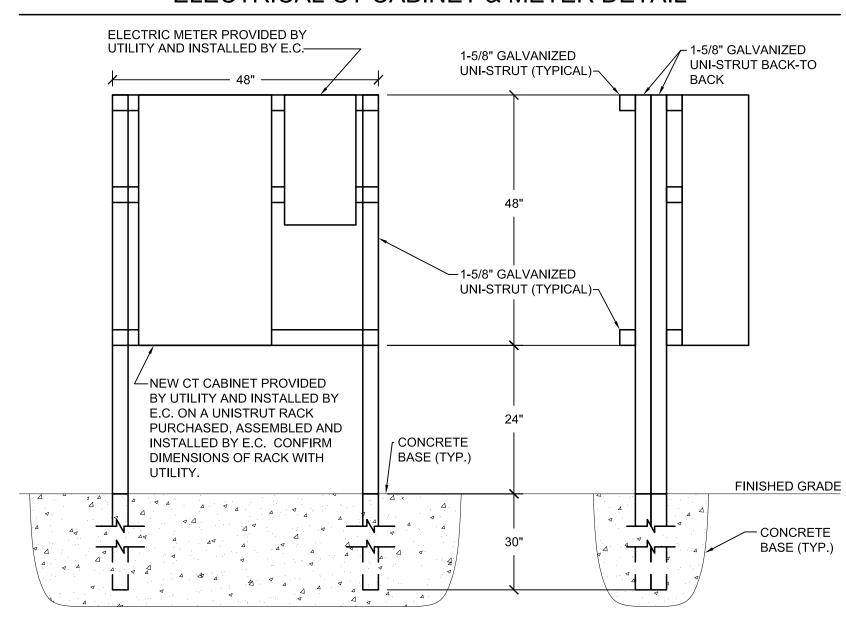

PANEL#G2A DETAIL

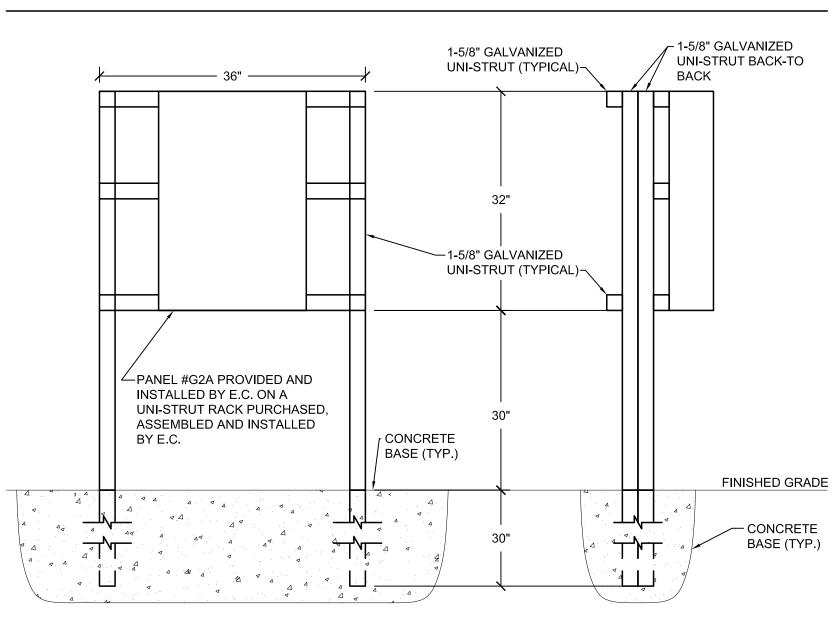

RECEPTACLE & DISCONNECT SWITCH DETAIL

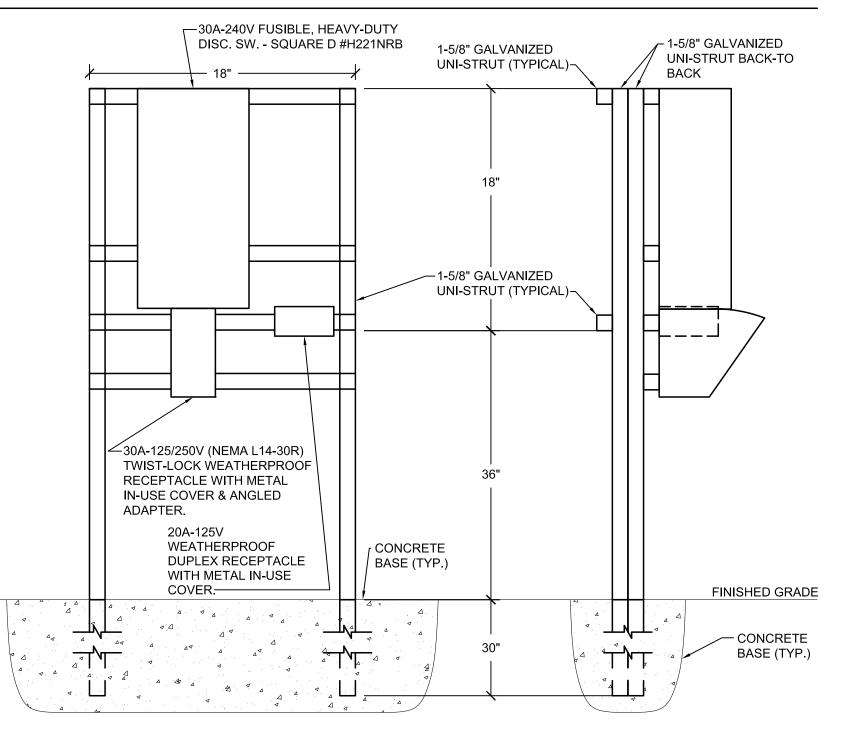

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VERINE I SE

18101 DRAWN BY:

ENGR PROJ# CHECKED BY: JAV DATE: 01.28.2021 Addendum #1

SHEET NUMBER

SE3

EXACT LOCATION WITH

E.C. SHALL VERIFY ALL ROUGH-IN ELEVATIONS, LOCATIONS AND/OR HEIGHTS OF ALL LIGHT FIXTURES, RECEPTACLE OUTLETS, T.V., COMPUTER, CLOCK OUTLETS, ETC. WITH ARCHITECT/ENGINEER. FAILURE TO DO SO WILL REQUIRE E.C. TO RELOCATE RESPECTIVE ITEMS AT THE E.C.'S EXPENSE. COMMUNICATION OUTLET LOCATIONS SHALL BE COORDINATED WITH OWNER AND OWNER FURNITURE PLAN.

2. FEEDS TO NEW POWER, LIGHTING, LOW VOLTAGE AND FIRE ALARM DEVICES SHALL BE ATTEMPTED IN EVERY WAY TO BE INSTALLED FLUSH-MOUNT (RECESSED BEHIND THE WALL/CEILING SURFACE).

THERE SHALL BE NO EXPOSED CONDUITS AND BOXES, EXCEPT IN MECH. ROOMS, AND IN THE EQUIPMENT STORAGE #101 & #102 AS NOTED IN NOTE #9 BELOW.

- 3. PROVIDE KEVLAR PULL STRINGS IN ALL SPARE CONDUITS.
- 4. E.C. SHALL COORDINATE FEEDER ROUTING WITH PLUMBING, MECHANICAL AND LOW VOLTAGE CONTRACTORS.
- 5. ANY NEW CONDUIT PENETRATIONS THROUGH WALLS SHALL BE APPROPRIATELY FIRE-STOPPED, SMOKE-STOPPED OR CAULKED WHEN PENETRATION SIZE EXCEEDS CONDUIT SIZE OR AS WORK SCOPES NOTE
- 6. COORDINATE LOCATION OF SLEEVES ABOVE THE CEILING FOR DATA, TELEPHONE/ PAGING, TELEVISION, SECURITY, AND CLOCK SYSTEMS WITH THE OWNER.
- 7. COORDINATE CONDUIT SLEEVES WITHIN THE WALLS FOR DATA, TELEPHONE/ PAGING, TELEVISION, SECURITY, AND CLOCK SYSTEMS WITH THE OWNER. IN MECHANICAL ROOM #109, THE CONDUIT STUBS FOR LOW VOLTAGE OUTLETS, WIRELESS ACCESS POINTS, TELEVISION OUTLETS, CARD READER OUTLETS, ELECTRIC STRIKES AND CAMERA OUTLETS IF FED FROM UNDERGROUND SHALL EXTEND TO 36" AFF (PVC IS ACCEPTABLE), AND IF FED FROM ABOVE THE CEILING SHALL EXTEND TO NO LOWER THAN 7'-6" AFF (EMT IS ACCEPTABLE). ALL STUBS SHALL HAVE PULL STRINGS, BUSHINGS ON THE ENDS, & BE PROPERLY SUPPORTED.


8. EQUIPMENT STORAGE GAS DETECTION SYSTEMS: COORDINATE WITH M.C. TO CONTROL THE EQUIPMENT STORAGE EXHAUST FANS AND LOUVERS WITH THE GAS DETECTION CONTROLLERS, THE HUMIDSTAT, OR THE MANUAL TIMER SWITCH AS SHOWN.


9. EQUIPMENT STORAGE #101 & #102 NOTES:

A. THE AREAS ARE CONSIDERED 'MINOR REPAIR GARAGES' PER ARTICLE 511 OF THE 2017 NEC AND ARE THEREFORE UNCLASSIFIED.

B. HOWEVER, ALL ELECTRICAL DEVICES AND EQUIPMENT SHALL BE LOCATED AND INSTALLED ABOVE 18" AFF.

- C. ALL CONDUIT FEEDS TO ELECTRICAL EQUIPMENT AND DEVICES MAY BE FROM ABOVE OR FROM UNDERGROUND. IF THE CONDUIT FEEDS ARE FROM ABOVE THE CONDUITS MAY BE SURFACE MOUNTED. IF THE CONDUIT FEEDS ARE FROM UNDERGROUND THE CONDUITS SHALL BE RECESSED WITHIN THE WALL CAVITY. IN EITHER INSTALLATION METHOD THE DEVICES SHALL BE SURFACE MOUNTED AND COORDINATED WITH THE CORRUGATED METAL WALL PANELS.
- D. THE LOCATION OF THE OVERHEAD DOOR MOTOR CONTROLS AND POWER CONNECTION LOCATIONS SHALL BE COORDINATED WITH THE DOOR SUPPLIER/ INSTALLER.
- E. ALL CONDUIT, BOXES AND EQUIPMENT INSTALLED ABOVE THE VEHICLE LIFT AREAS SHALL BE HELD TIGHT TO THE CEILING DECK.
- 10. WHEN INSTALLING THE WELDER AND PRESSURE WASHER RECEPTACLES; PLACE THE GROUND PRONG DOWN ON THE WELDER RECEPTACLES, AND THE GROUND PRONG UP ON THE PRESSURE WASHER RECEPTACLES.

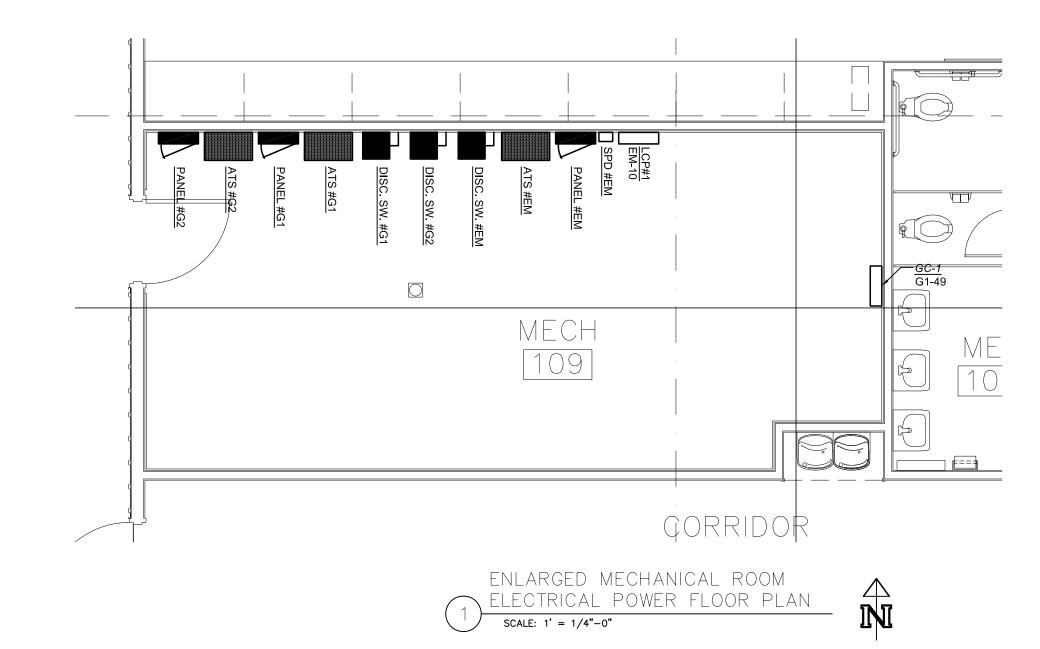

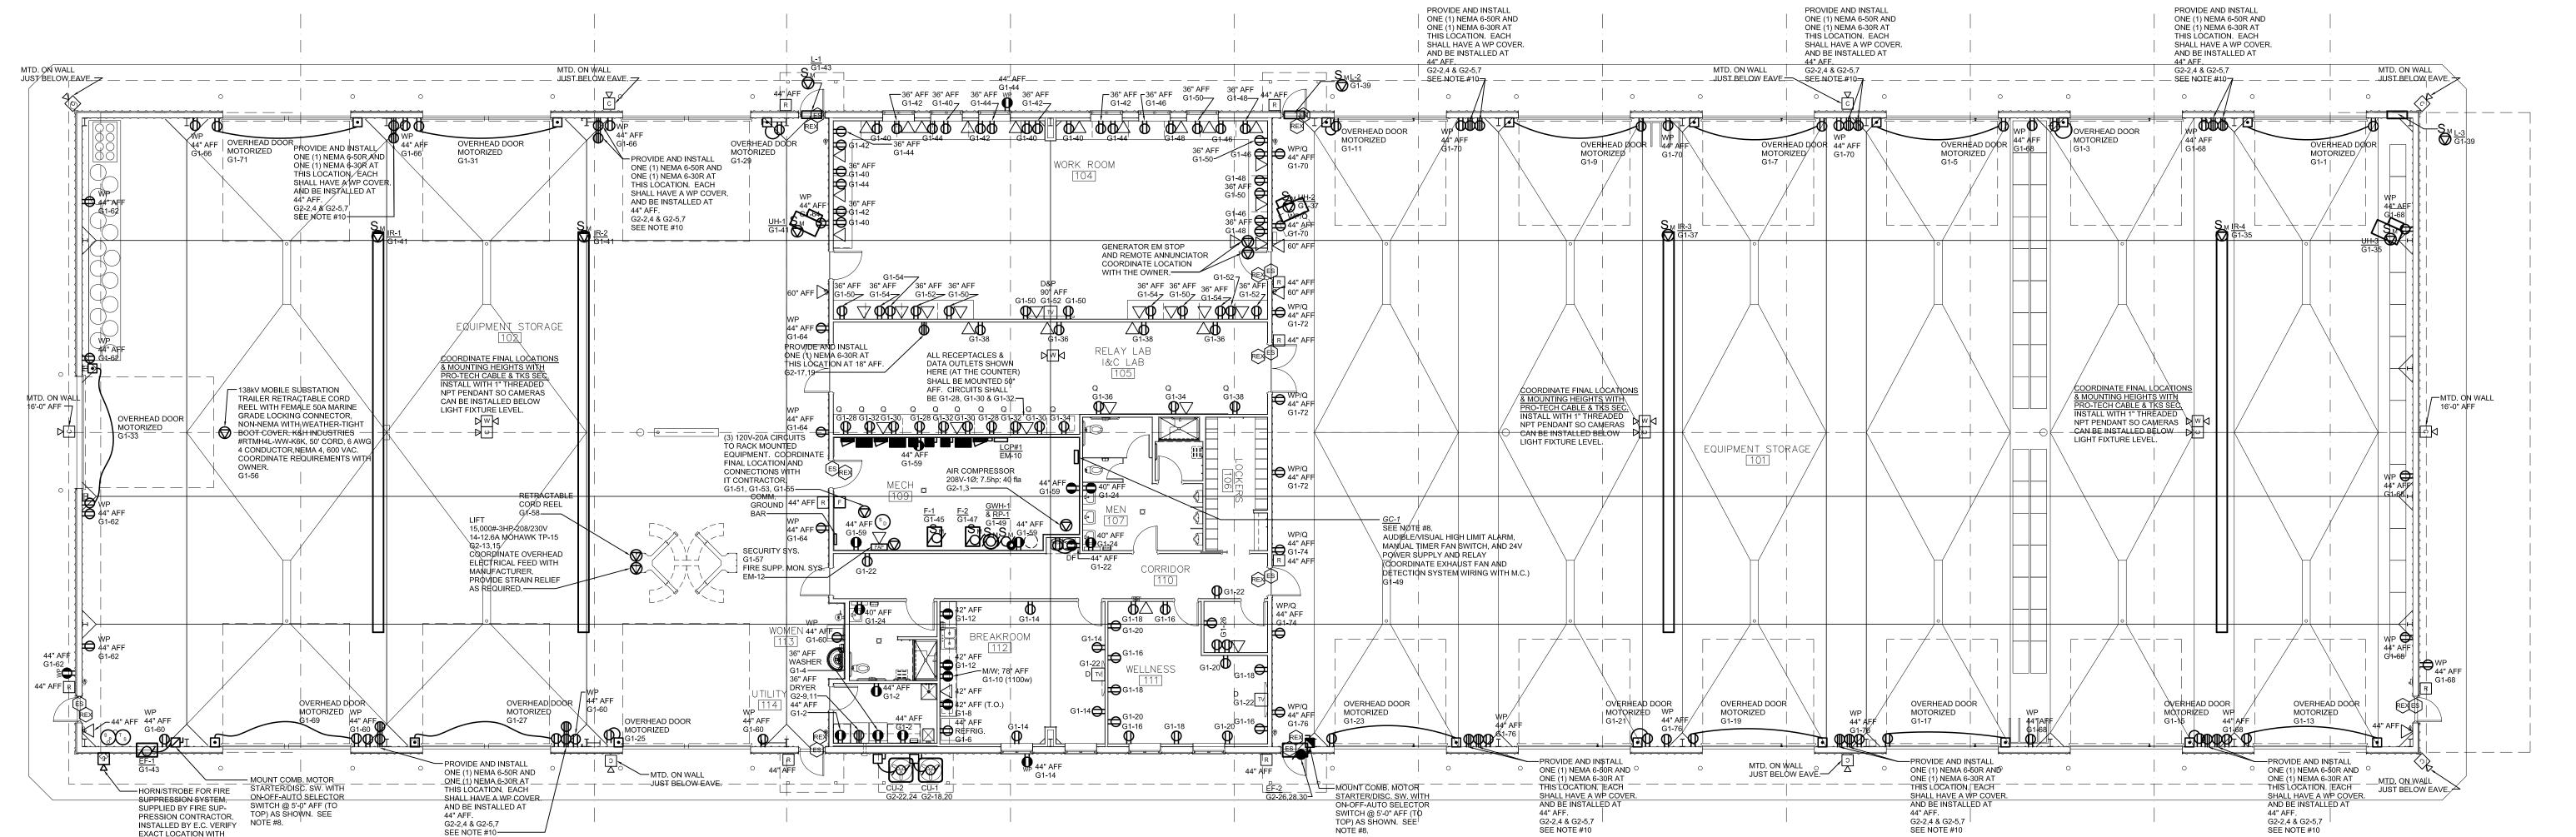





SEE NOTE #10


VERINE I SE

ENGR PROJ# 18101 DRAWN BY: CHECKED BY: JAV

DATE: 01.28.2021 dding & Construct 02.19.2021 Addendum #1

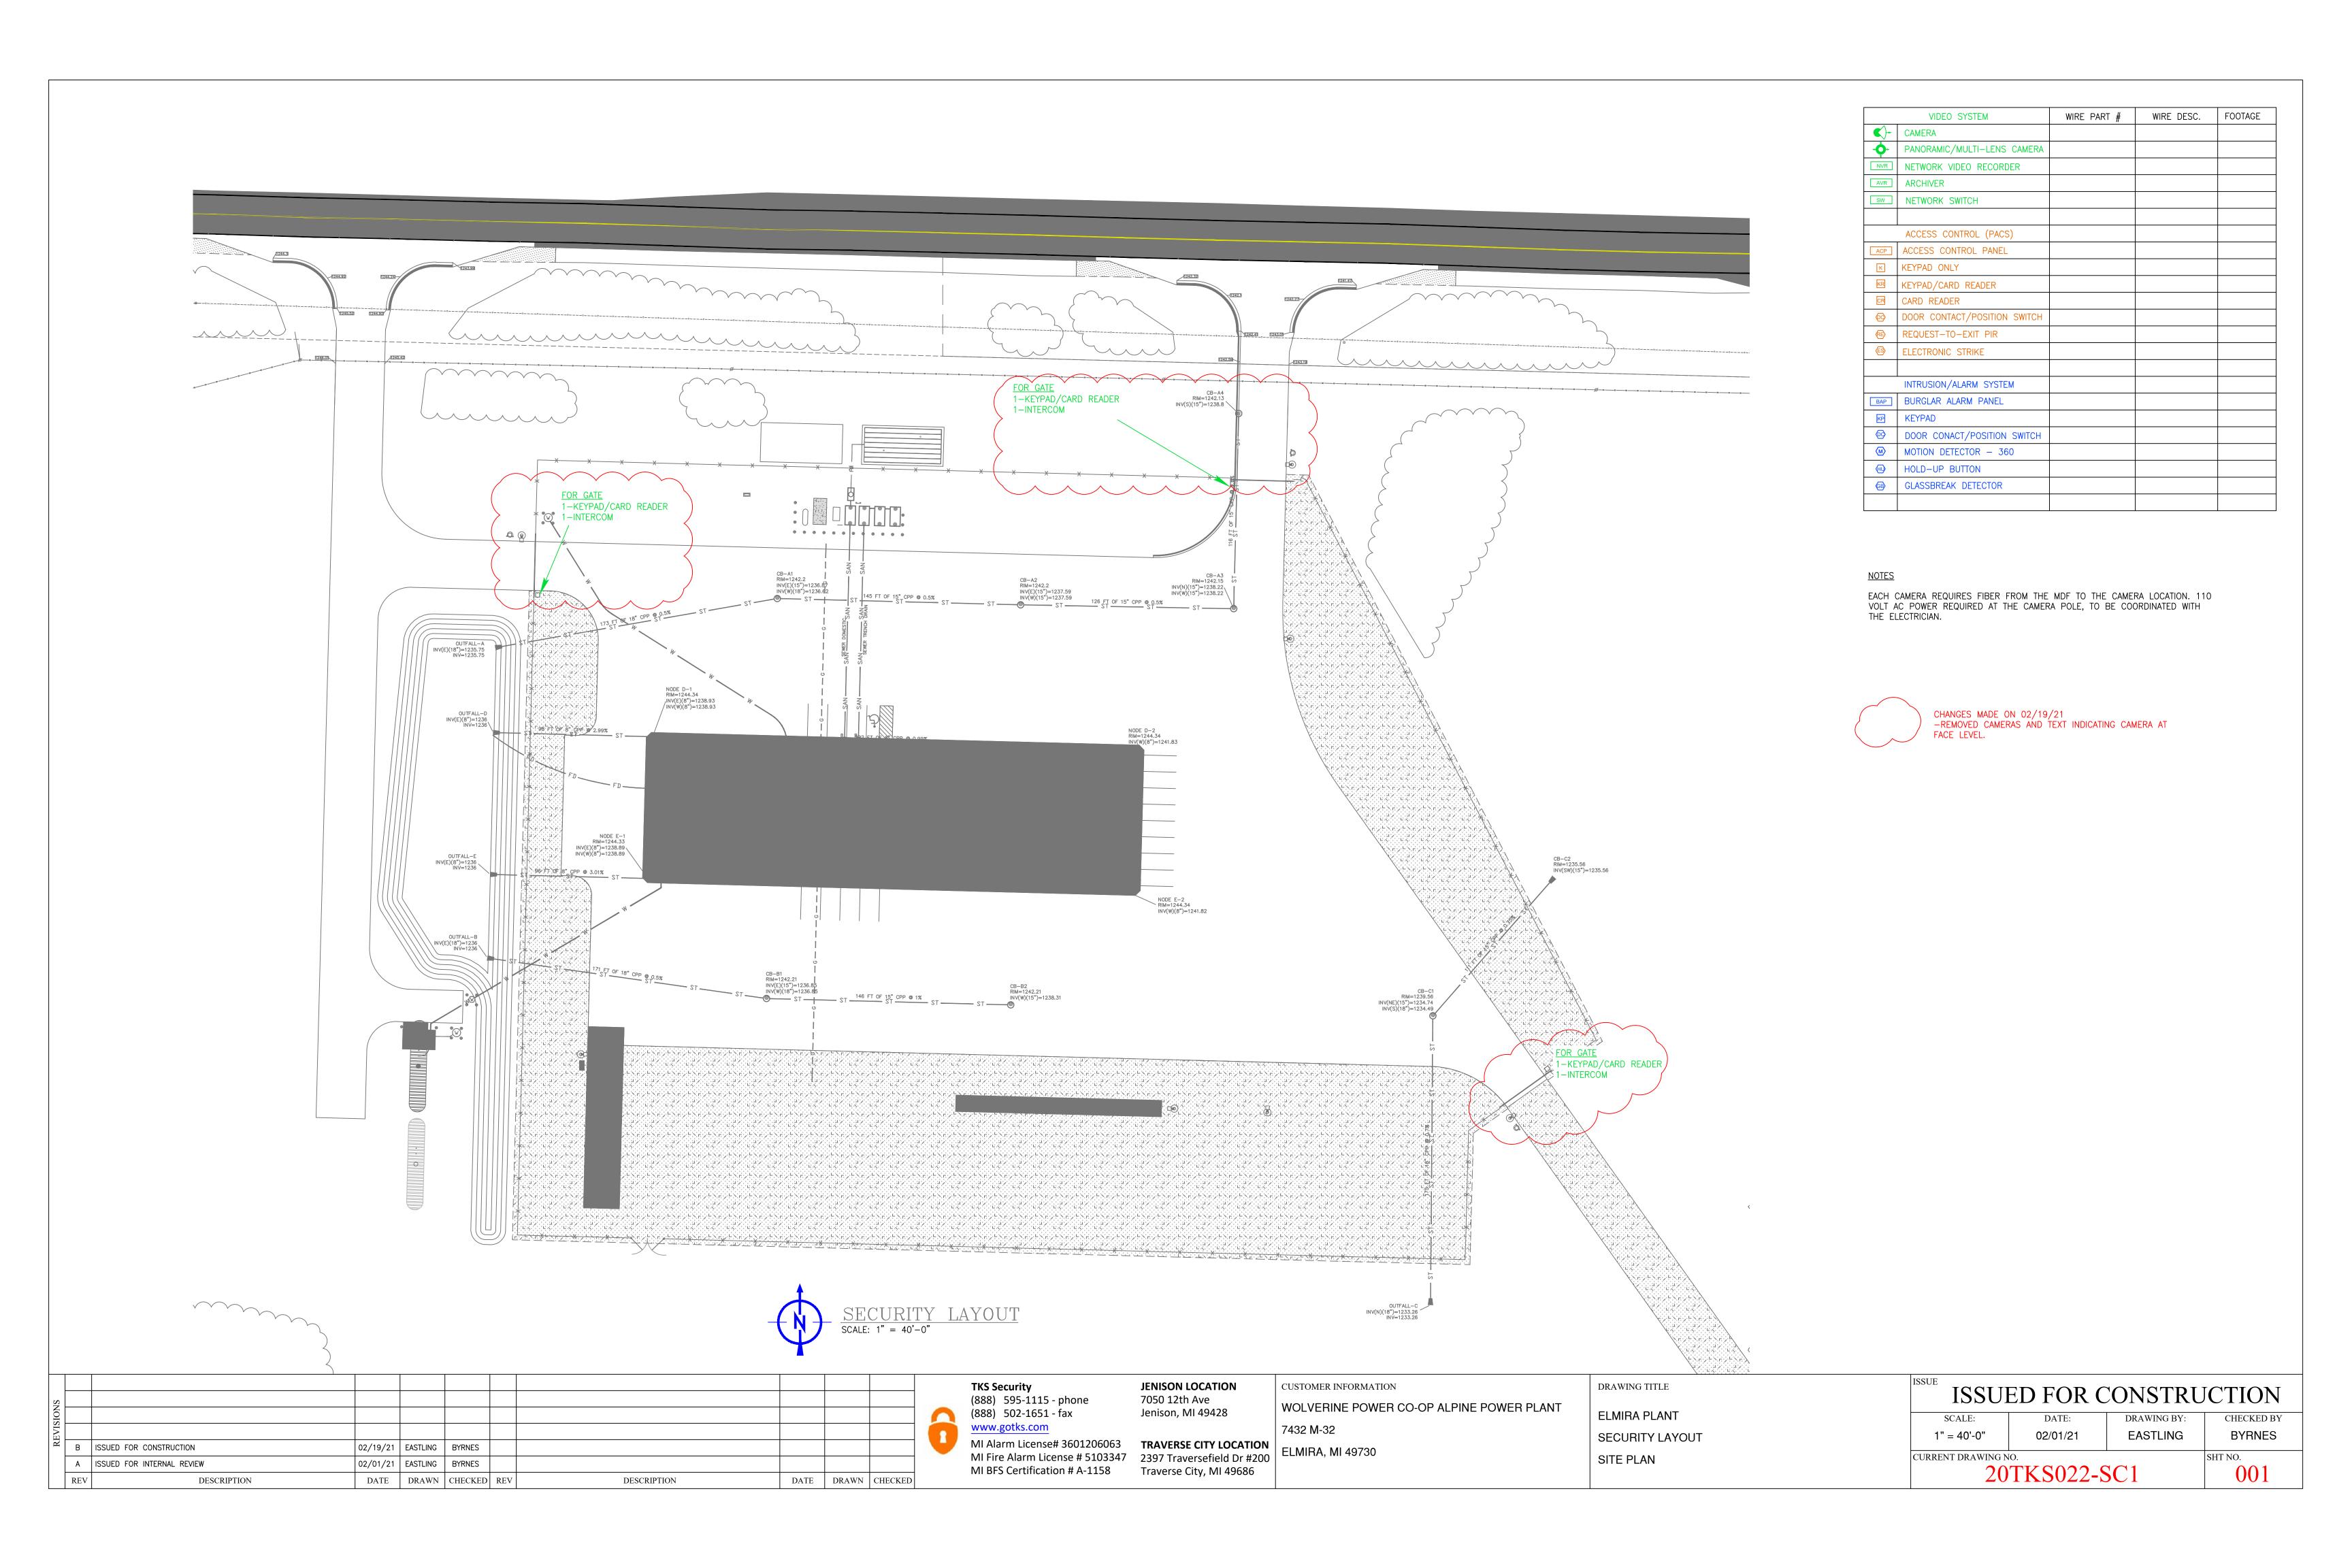

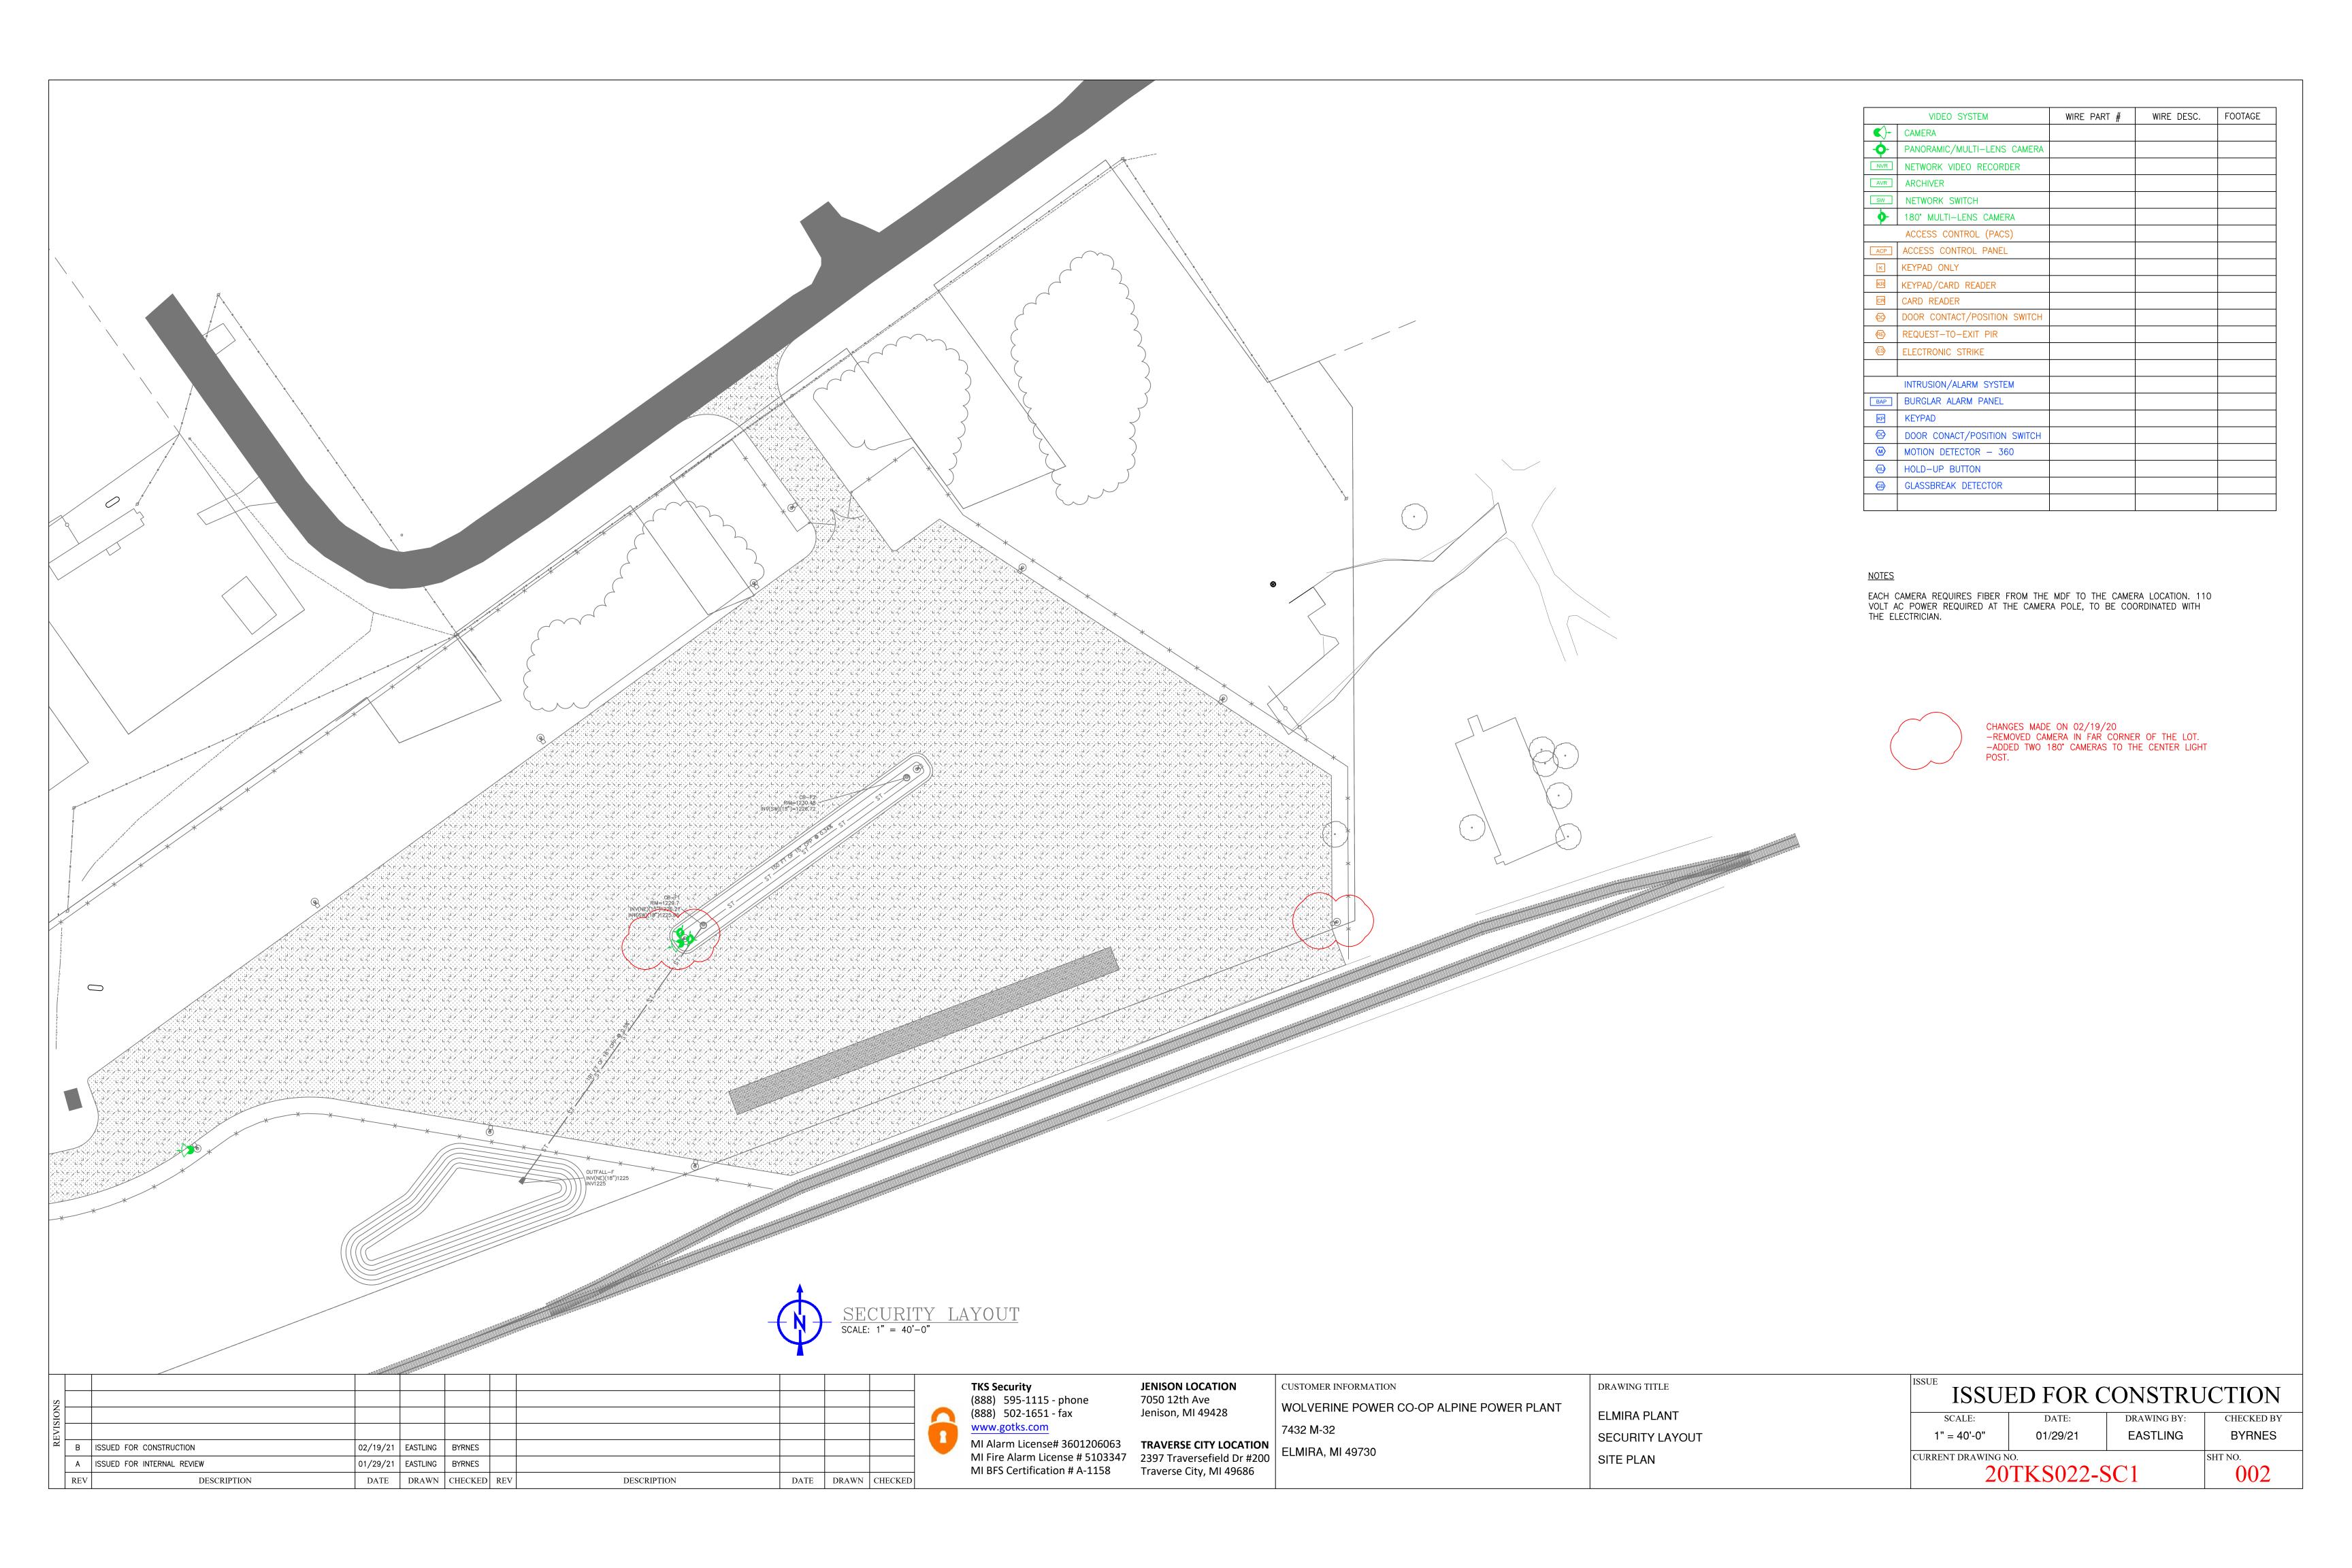

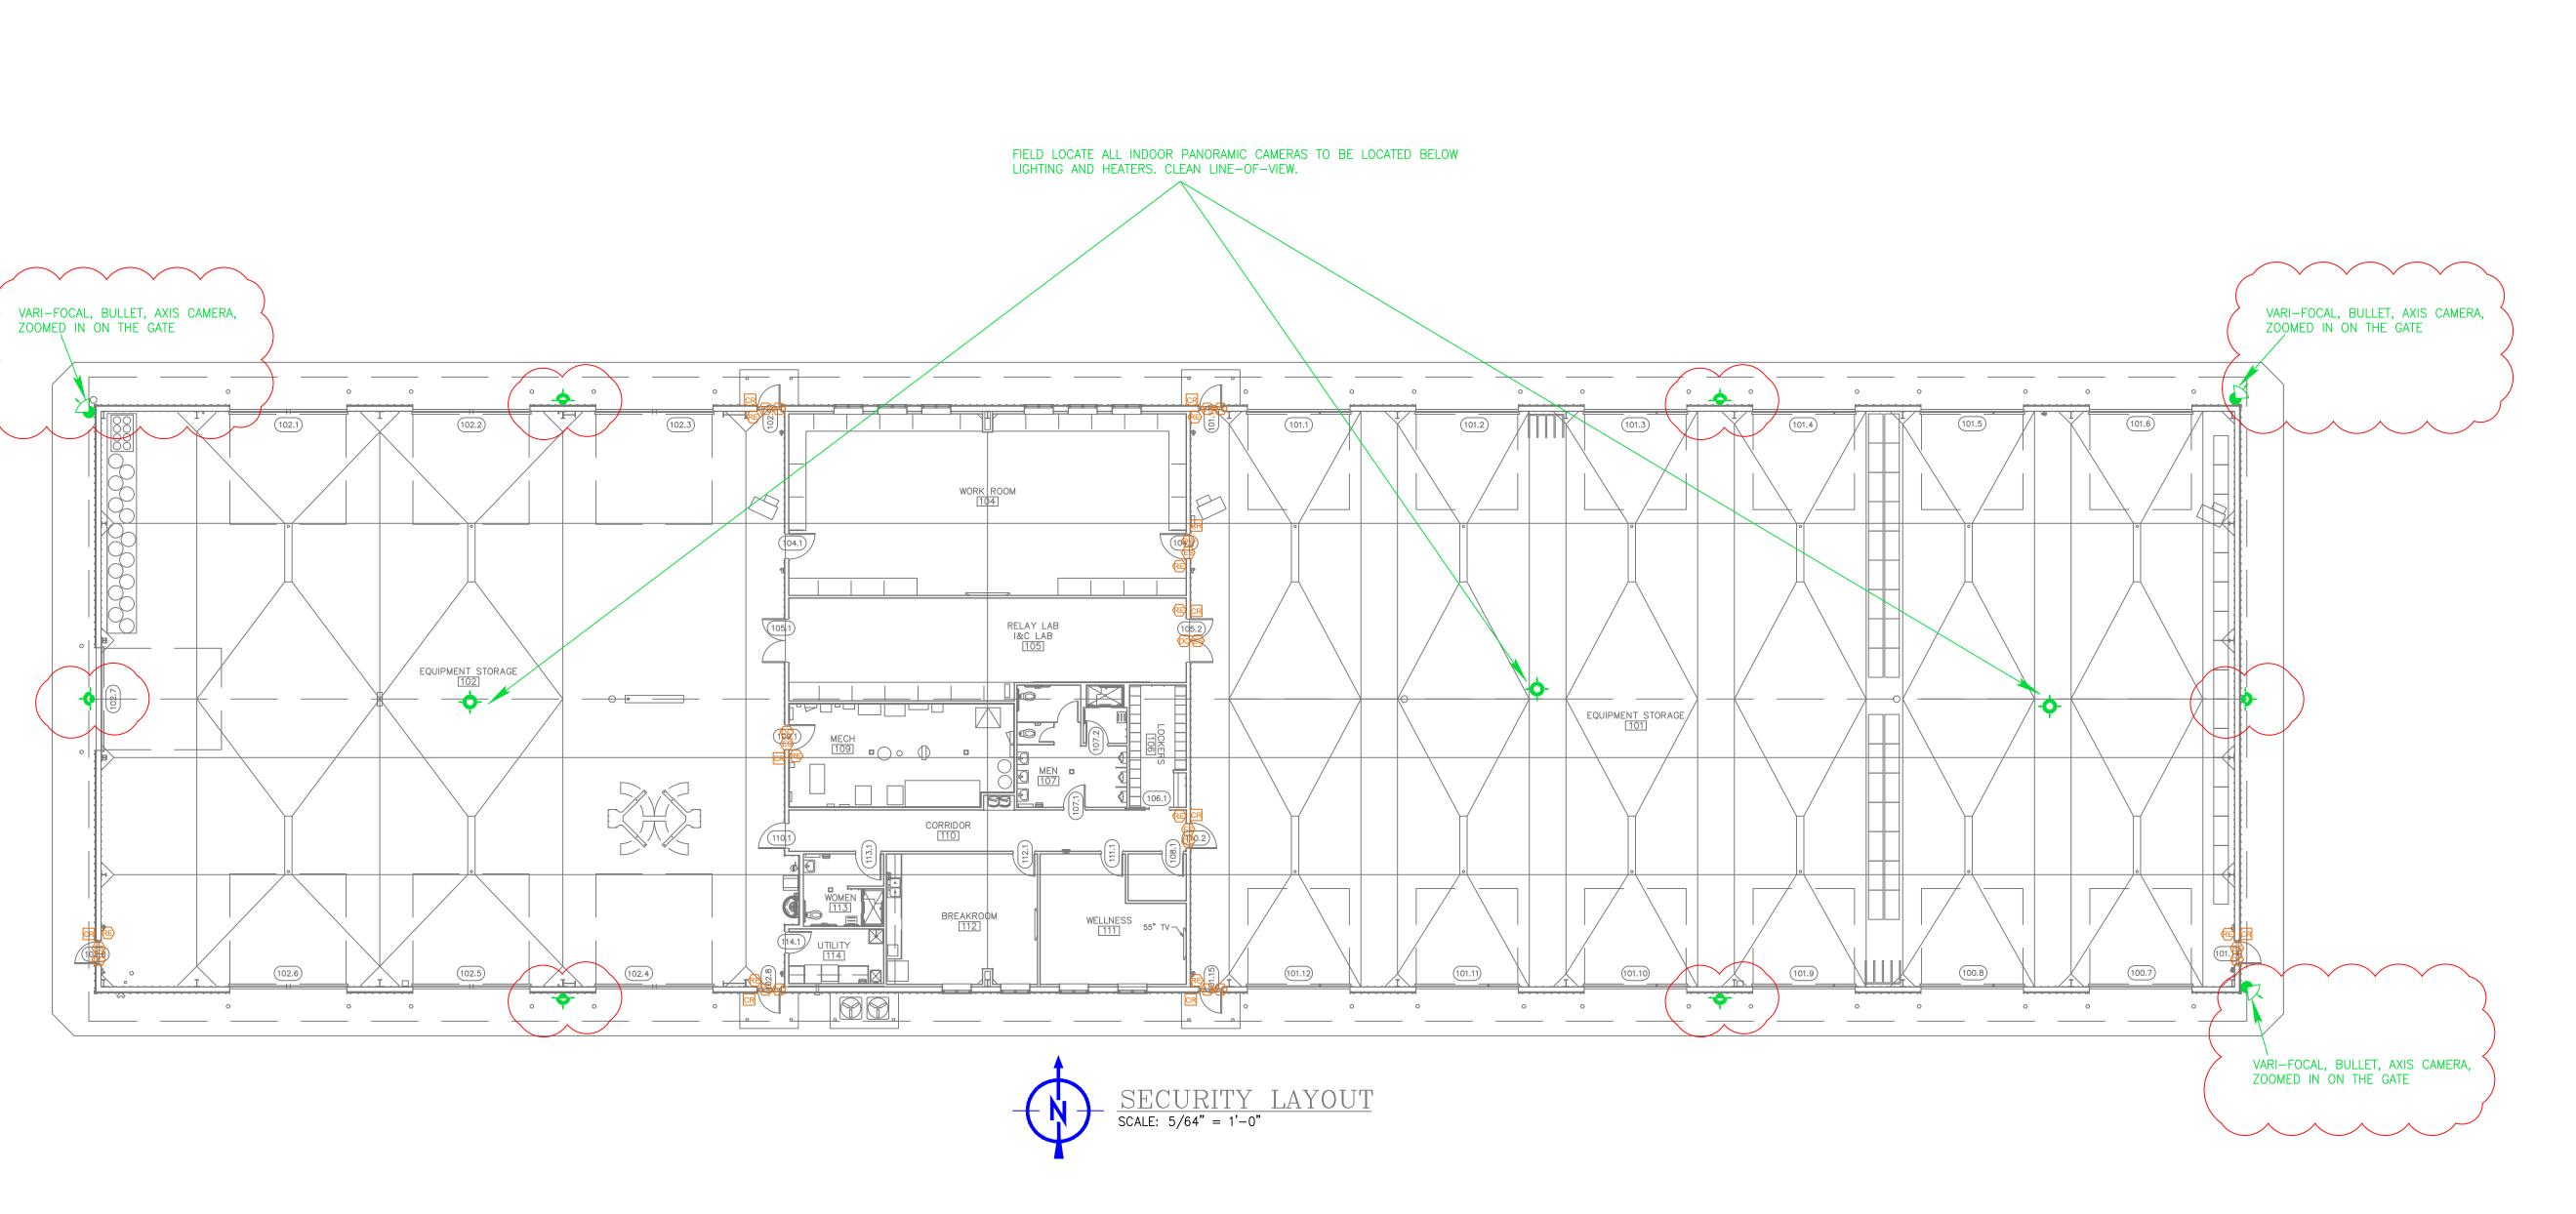

	VIDEO SYSTEM	WIRE PART #	WIRE DESC.	FOOTAGE
C)-	CAMERA			
-•	PANORAMIC/MULTI-LENS CAMERA			
NVR	NETWORK VIDEO RECORDER			
AVR	ARCHIVER			
SW	NETWORK SWITCH			
•	180° MULTI-LENS CAMERA			
	ACCESS CONTROL (PACS)			
ACP	ACCESS CONTROL PANEL			
К	KEYPAD ONLY			
KR	KEYPAD/CARD READER			
CR	CARD READER			
60	DOOR CONTACT/POSITION SWITCH			
₹₽	REQUEST-TO-EXIT PIR			
(ES)	ELECTRONIC STRIKE			
	INTRUSION/ALARM SYSTEM			
BAP	BURGLAR ALARM PANEL			
KP	KEYPAD			
©	DOOR CONACT/POSITION SWITCH			
M	MOTION DETECTOR - 360			
(HI)	HOLD-UP BUTTON			
€ B	GLASSBREAK DETECTOR			



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국 [В	ISSUED FOR CONSTRUCTION	02/19/21	EASTLING	BYRNES					
	Α	ISSUED FOR INTERNAL REVIEW	12/07/20	EASTLING	BYRNES					
	REV	DESCRIPTION	DATE	DRAWN	CHECKED	REV	DESCRIPTION	DATE	DRAWN	CHECKED

TKS Security (888) 595-1115 - phone (888) 502-1651 - fax www.gotks.com MI Alarm License# 3601206063 TRAVERSE CITY LOCATION

JENISON LOCATION 7050 12th Ave Jenison, MI 49428

MI Fire Alarm License # 5103347 2397 Traversefield Dr #200 MI BFS Certification # A-1158 Traverse City, MI 49686


CUSTOMER INFORMATION WOLVERINE POWER CO-OP ALPINE POWER PLANT 7432 M-32


ELMIRA, MI 49730


DRAWING TITLE ELMIRA PLANT SECURITY LAYOUT 1ST FLOOR

ISSUI ISSUI	ED FOR C	CONSTRU	CTION
SCALE:	DATE:	DRAWING BY:	CHECKED BY
5/64" = 1'-0"	12/07/20	EASTLING	BYRNES
CURRENT DRAWING N	SHT NO.		
20	003		

	DATA/PHONE SYSTEM	WIRE PART #	WIRE DESC.	FOOTAGE
∇	DUEL CAT6 DATA DROP			
((1-1))	DUAL CAT6 ACCESS POINT (WAP)			

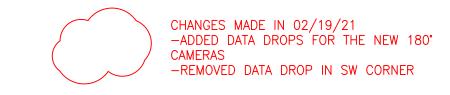

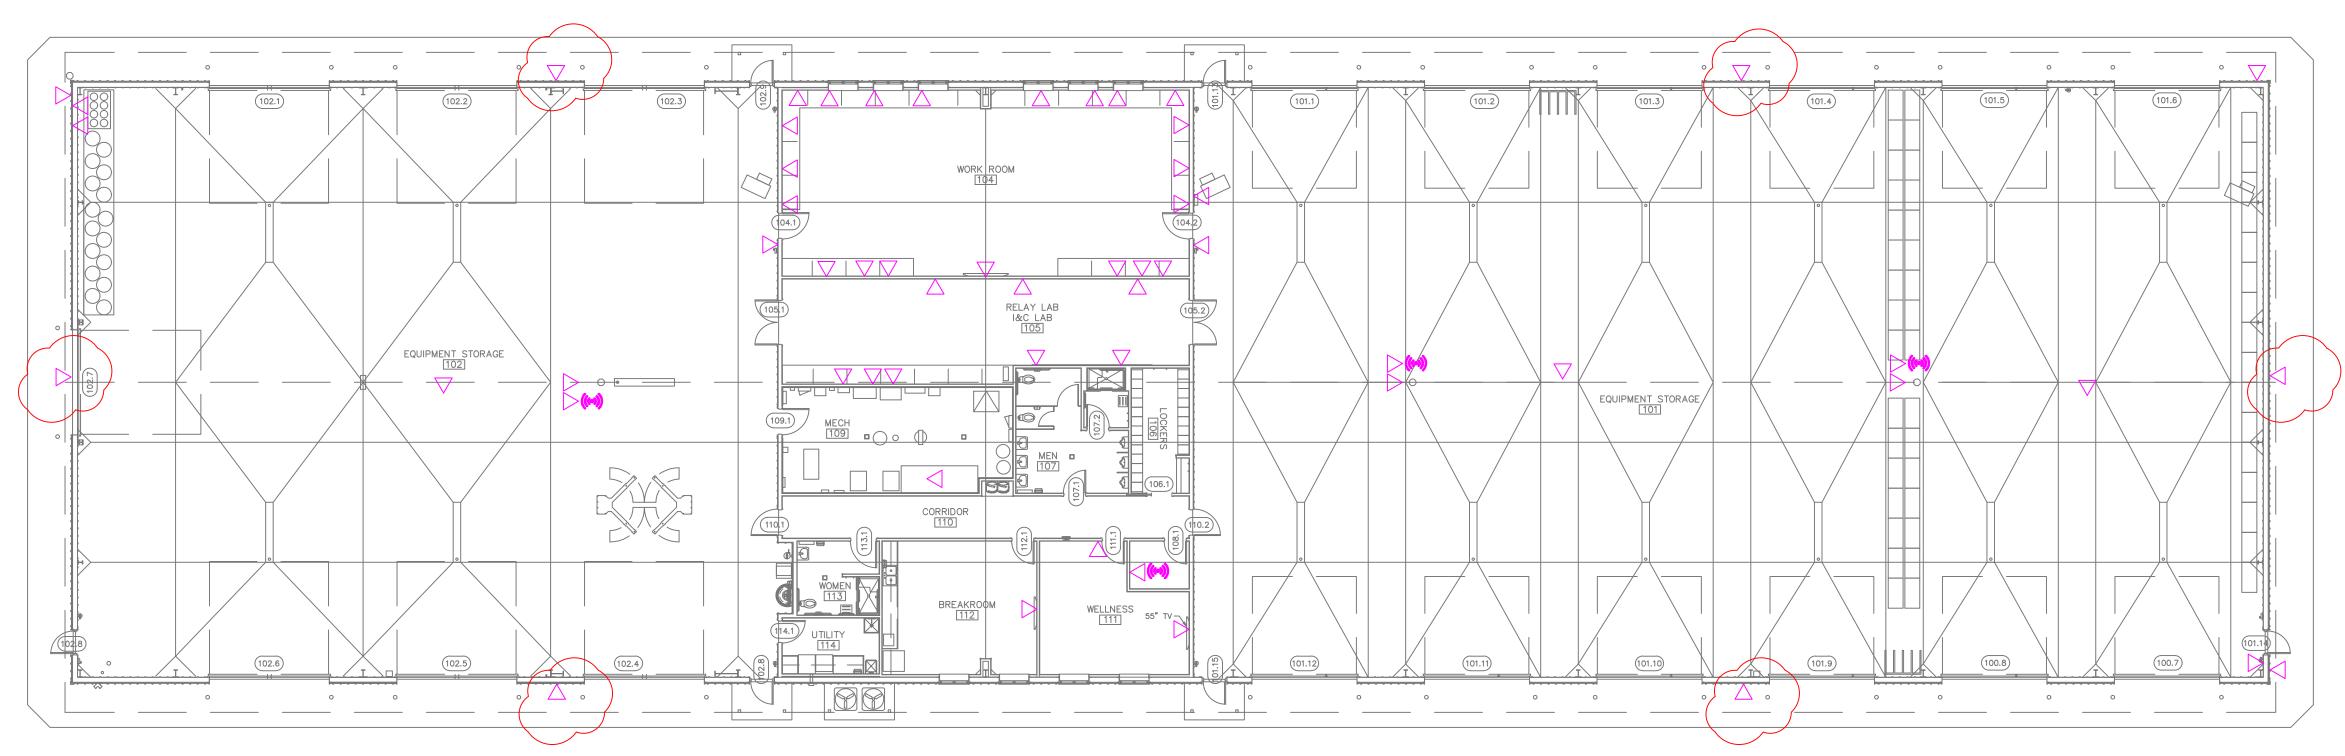

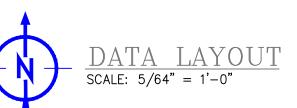

SI											
SIONS											
REVIS											
2	В	ISSUED FOR CONSTRUCTION	02/19/21	EASTLING	BYRNES						
	Α	ISSUED FOR INTERNAL REVIEW	01/04/20	EASTLING	BYRNES						
	REV	DESCRIPTION	DATE	DRAWN	CHECKED	REV	DESCRIPTION	DATE	DRAWN	CHECKED	
	•										

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CUSTOMER INFORMATION WOLVERINE POWER CO-OP ALPINE POWER PLANT 7432 M-32

ELMIRA, MI 49730

	DRAWING TITLE
	ELMIRA PLANT
	DATA LAYOUT
	1ST FLOOR

ISSUED FOR CONSTRUCTION SCALE: DRAWING BY: CHECKED BY **EASTLING BYRNES** 01/04/20 5/64" = 1'-0" CURRENT DRAWING NO. SHT NO. 20TKS022-SC1 004